




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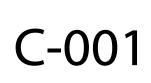
	FOUND MONUMENT AS NOTED
■ >	CATCH BASIN CENTER STORM CULVERT
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$\langle \times \rangle$	EXCEPTION NUMBER
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T	UNDERGROUND TELE-COM LINE
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	CONCRETE
AC	ASPHALT CONCRETE
CONC.	CONCRETE
DOC. NO.	DOCUMENT NUMBER, WASHINGTON COUNTY DEED RECORDS
IR	IRON ROD
W/	WITH
ALC	ALUMINUM CAP
UNK	UNKNOWN
СМР	CORRUGATED METAL PIPE
	DELINEATED WETLAND BOUNDARY SROZ BOUNDARY (50' SETBACK)
	SROZ IMPACT AREA (25' SETBACK FROM
	PROPOSED TREE PROTECTION FENCING
	PROPOSED EROSION CONTROL SEDIMEN
X	REMOVE EXISTING TREE


RETE ALT CONCRETE RETE JMENT NUMBER, HINGTON COUNTY DEED RECORDS ROD INUM CAP NWC UGATED METAL PIPE NEATED WETLAND BOUNDARY Z BOUNDARY (50' SETBACK) IMPACT AREA (25' SETBACK FROM SROZ) POSED TREE PROTECTION FENCING POSED EROSION CONTROL SEDIMENT FENCING OVE EXISTING TREE

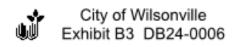

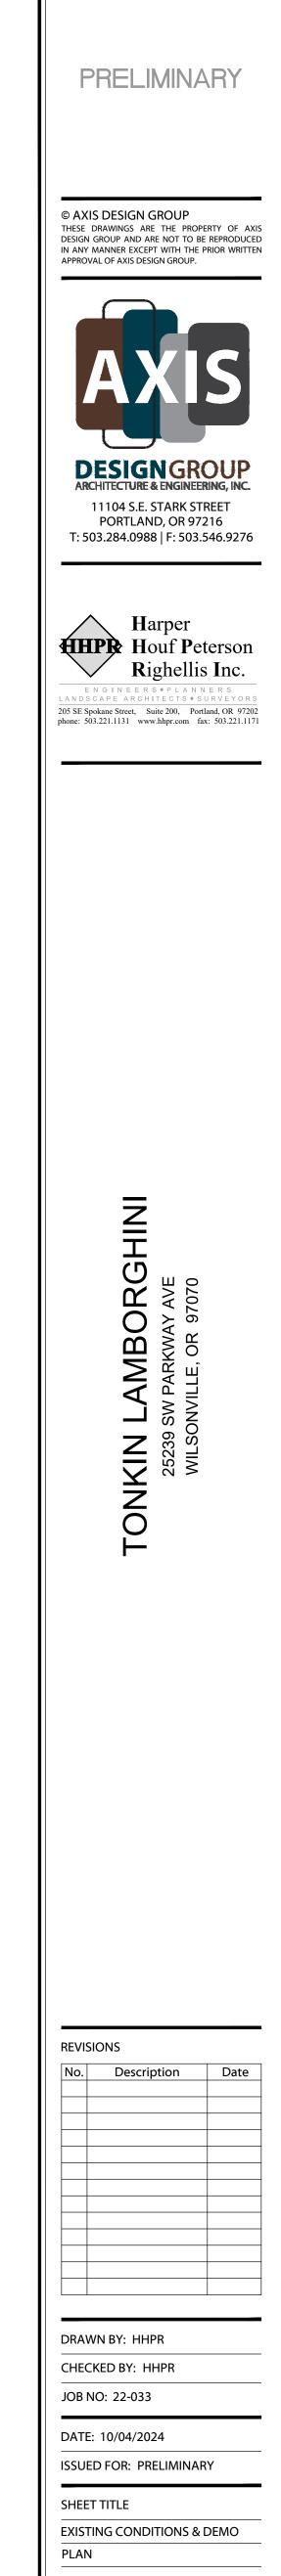



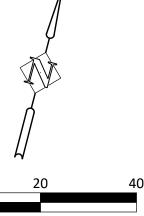

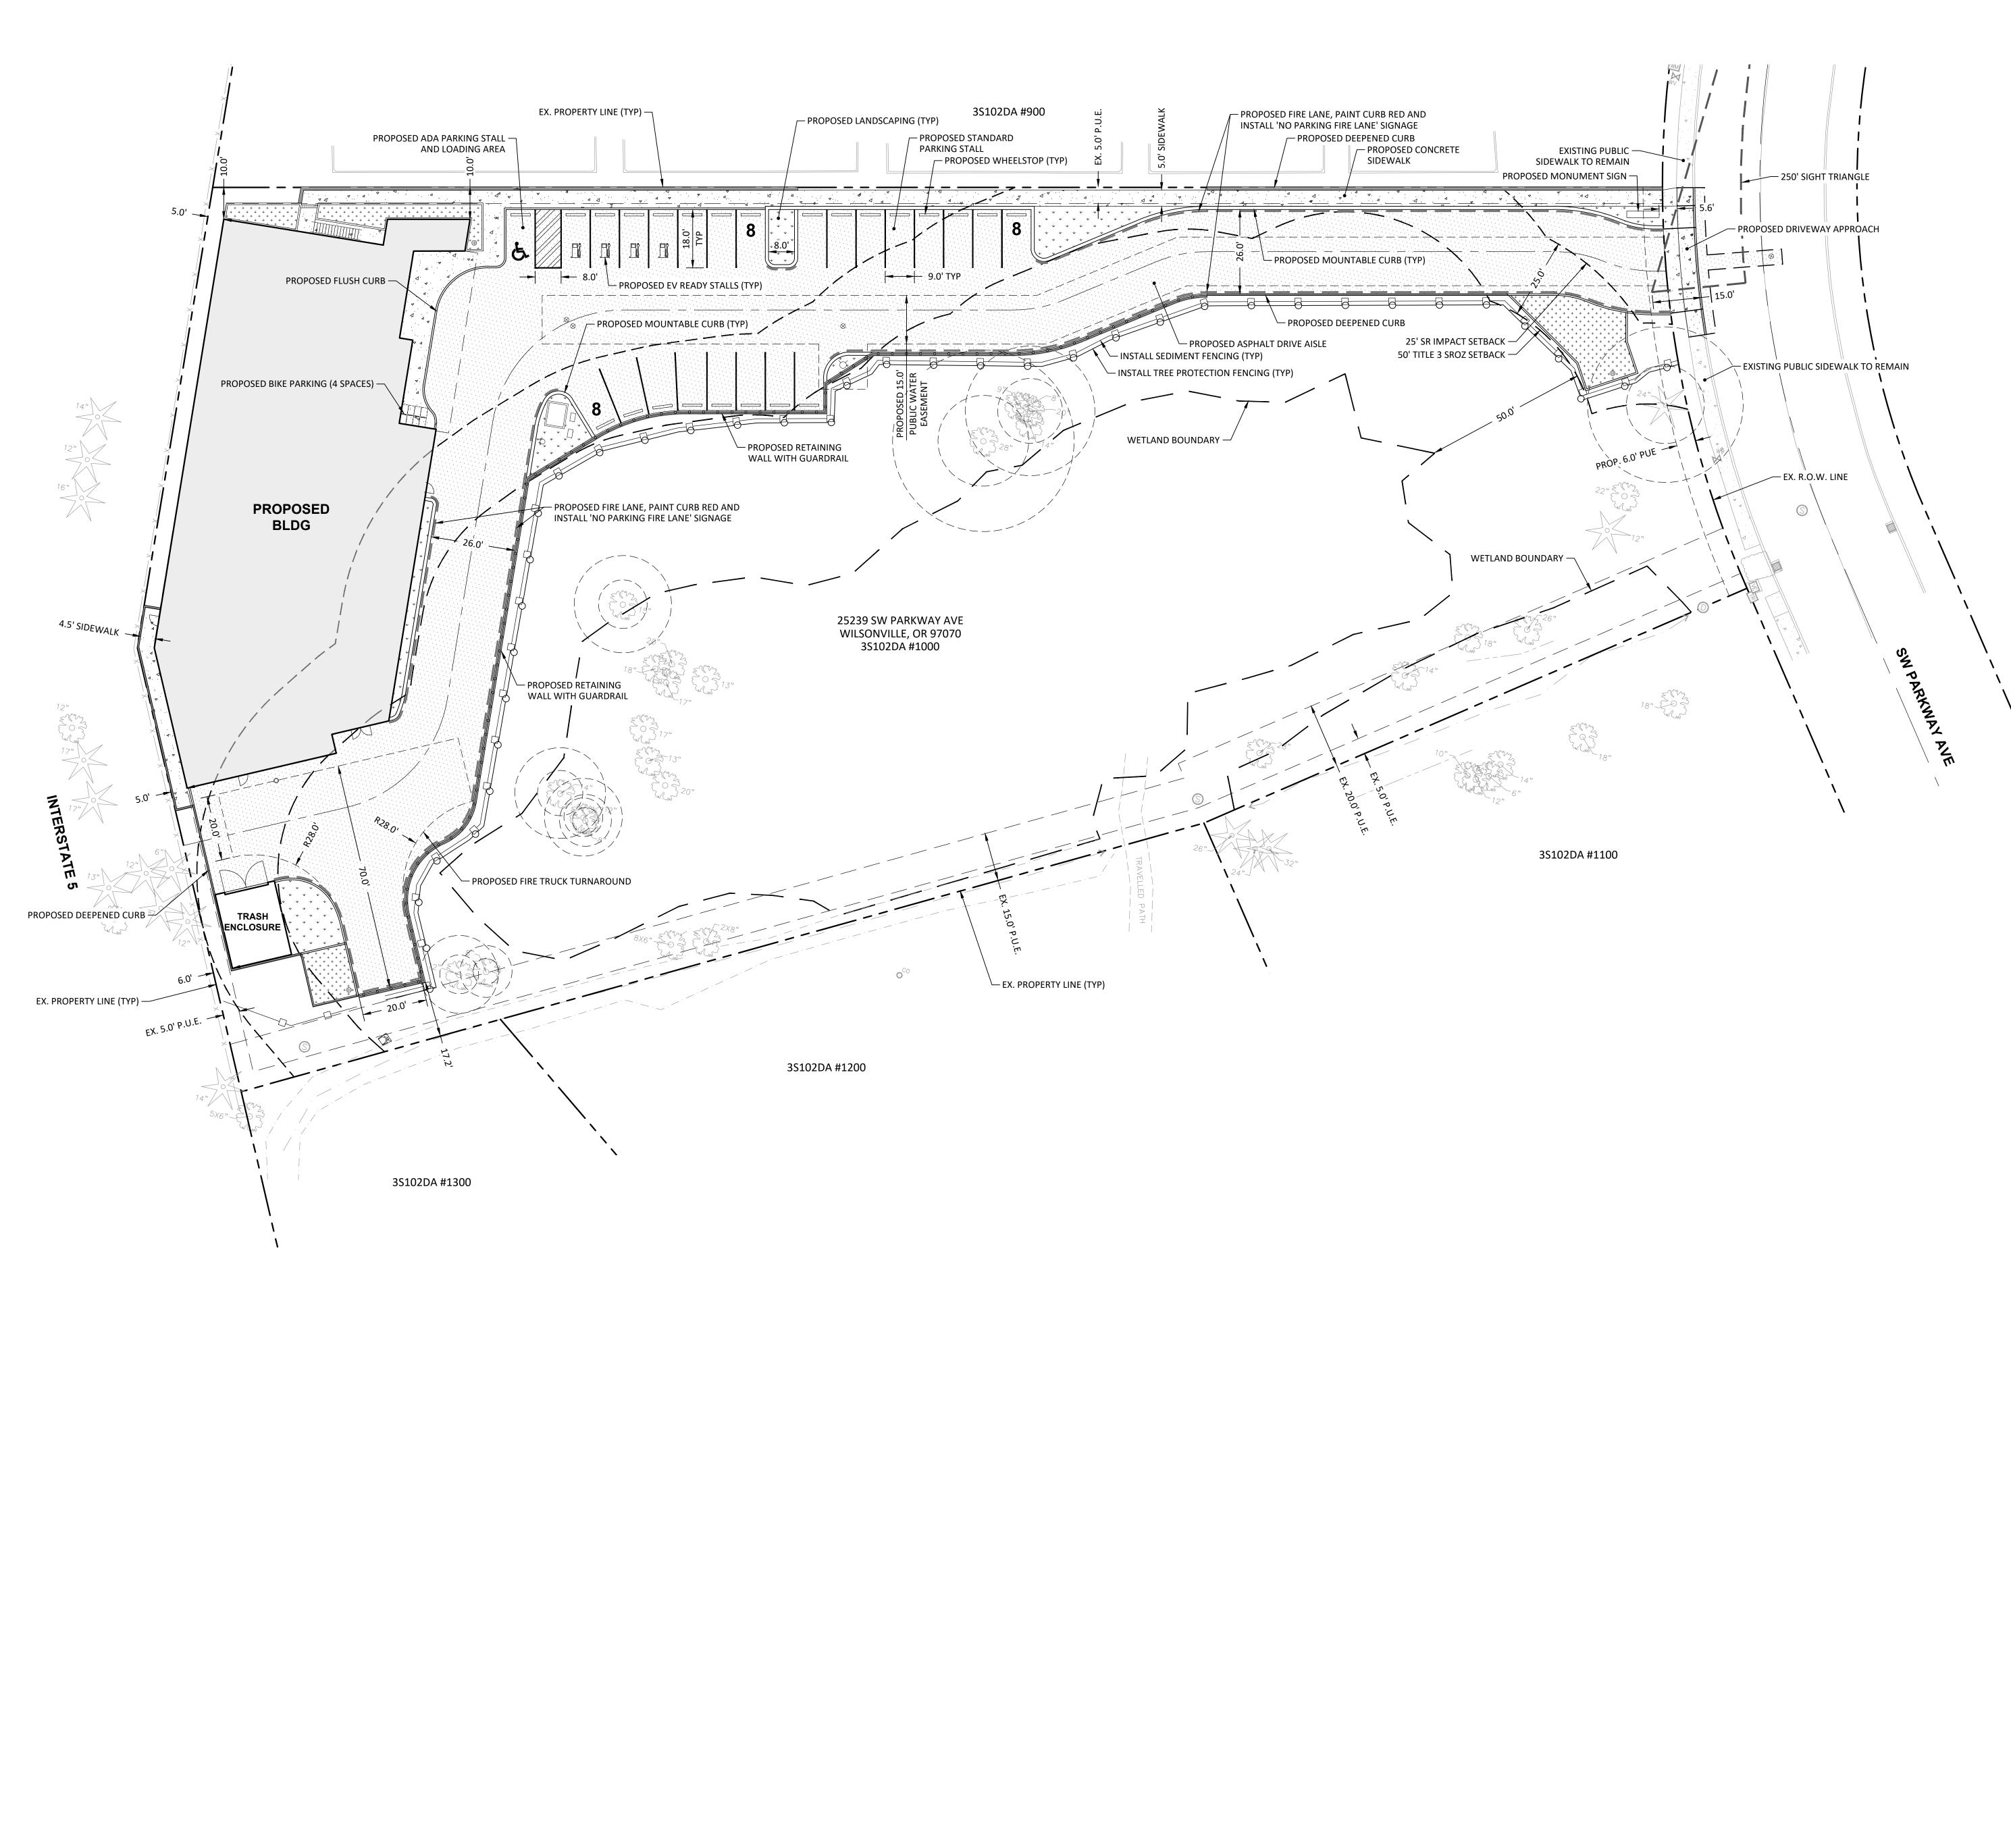


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EXISTING PROPERTY / RIGHT-OF-WAY LINE EXISTING EASEMENT DELINEATED WETLAND BOUNDARY SROZ BOUNDARY (50' SETBACK) SROZ IMPACT AREA (25' SETBACK FROM SROZ) PROPOSED TREE PROTECTION FENCING PROPOSED SEDIMENT FENCING PROPOSED GUARDRAILING PROPOSED STORM PLANTER PROPOSED GENERAL LANDSCAPING

PROPOSED ASPHALT PAVEMENT

PROPOSED CONCRETE SIDEWALK



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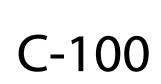
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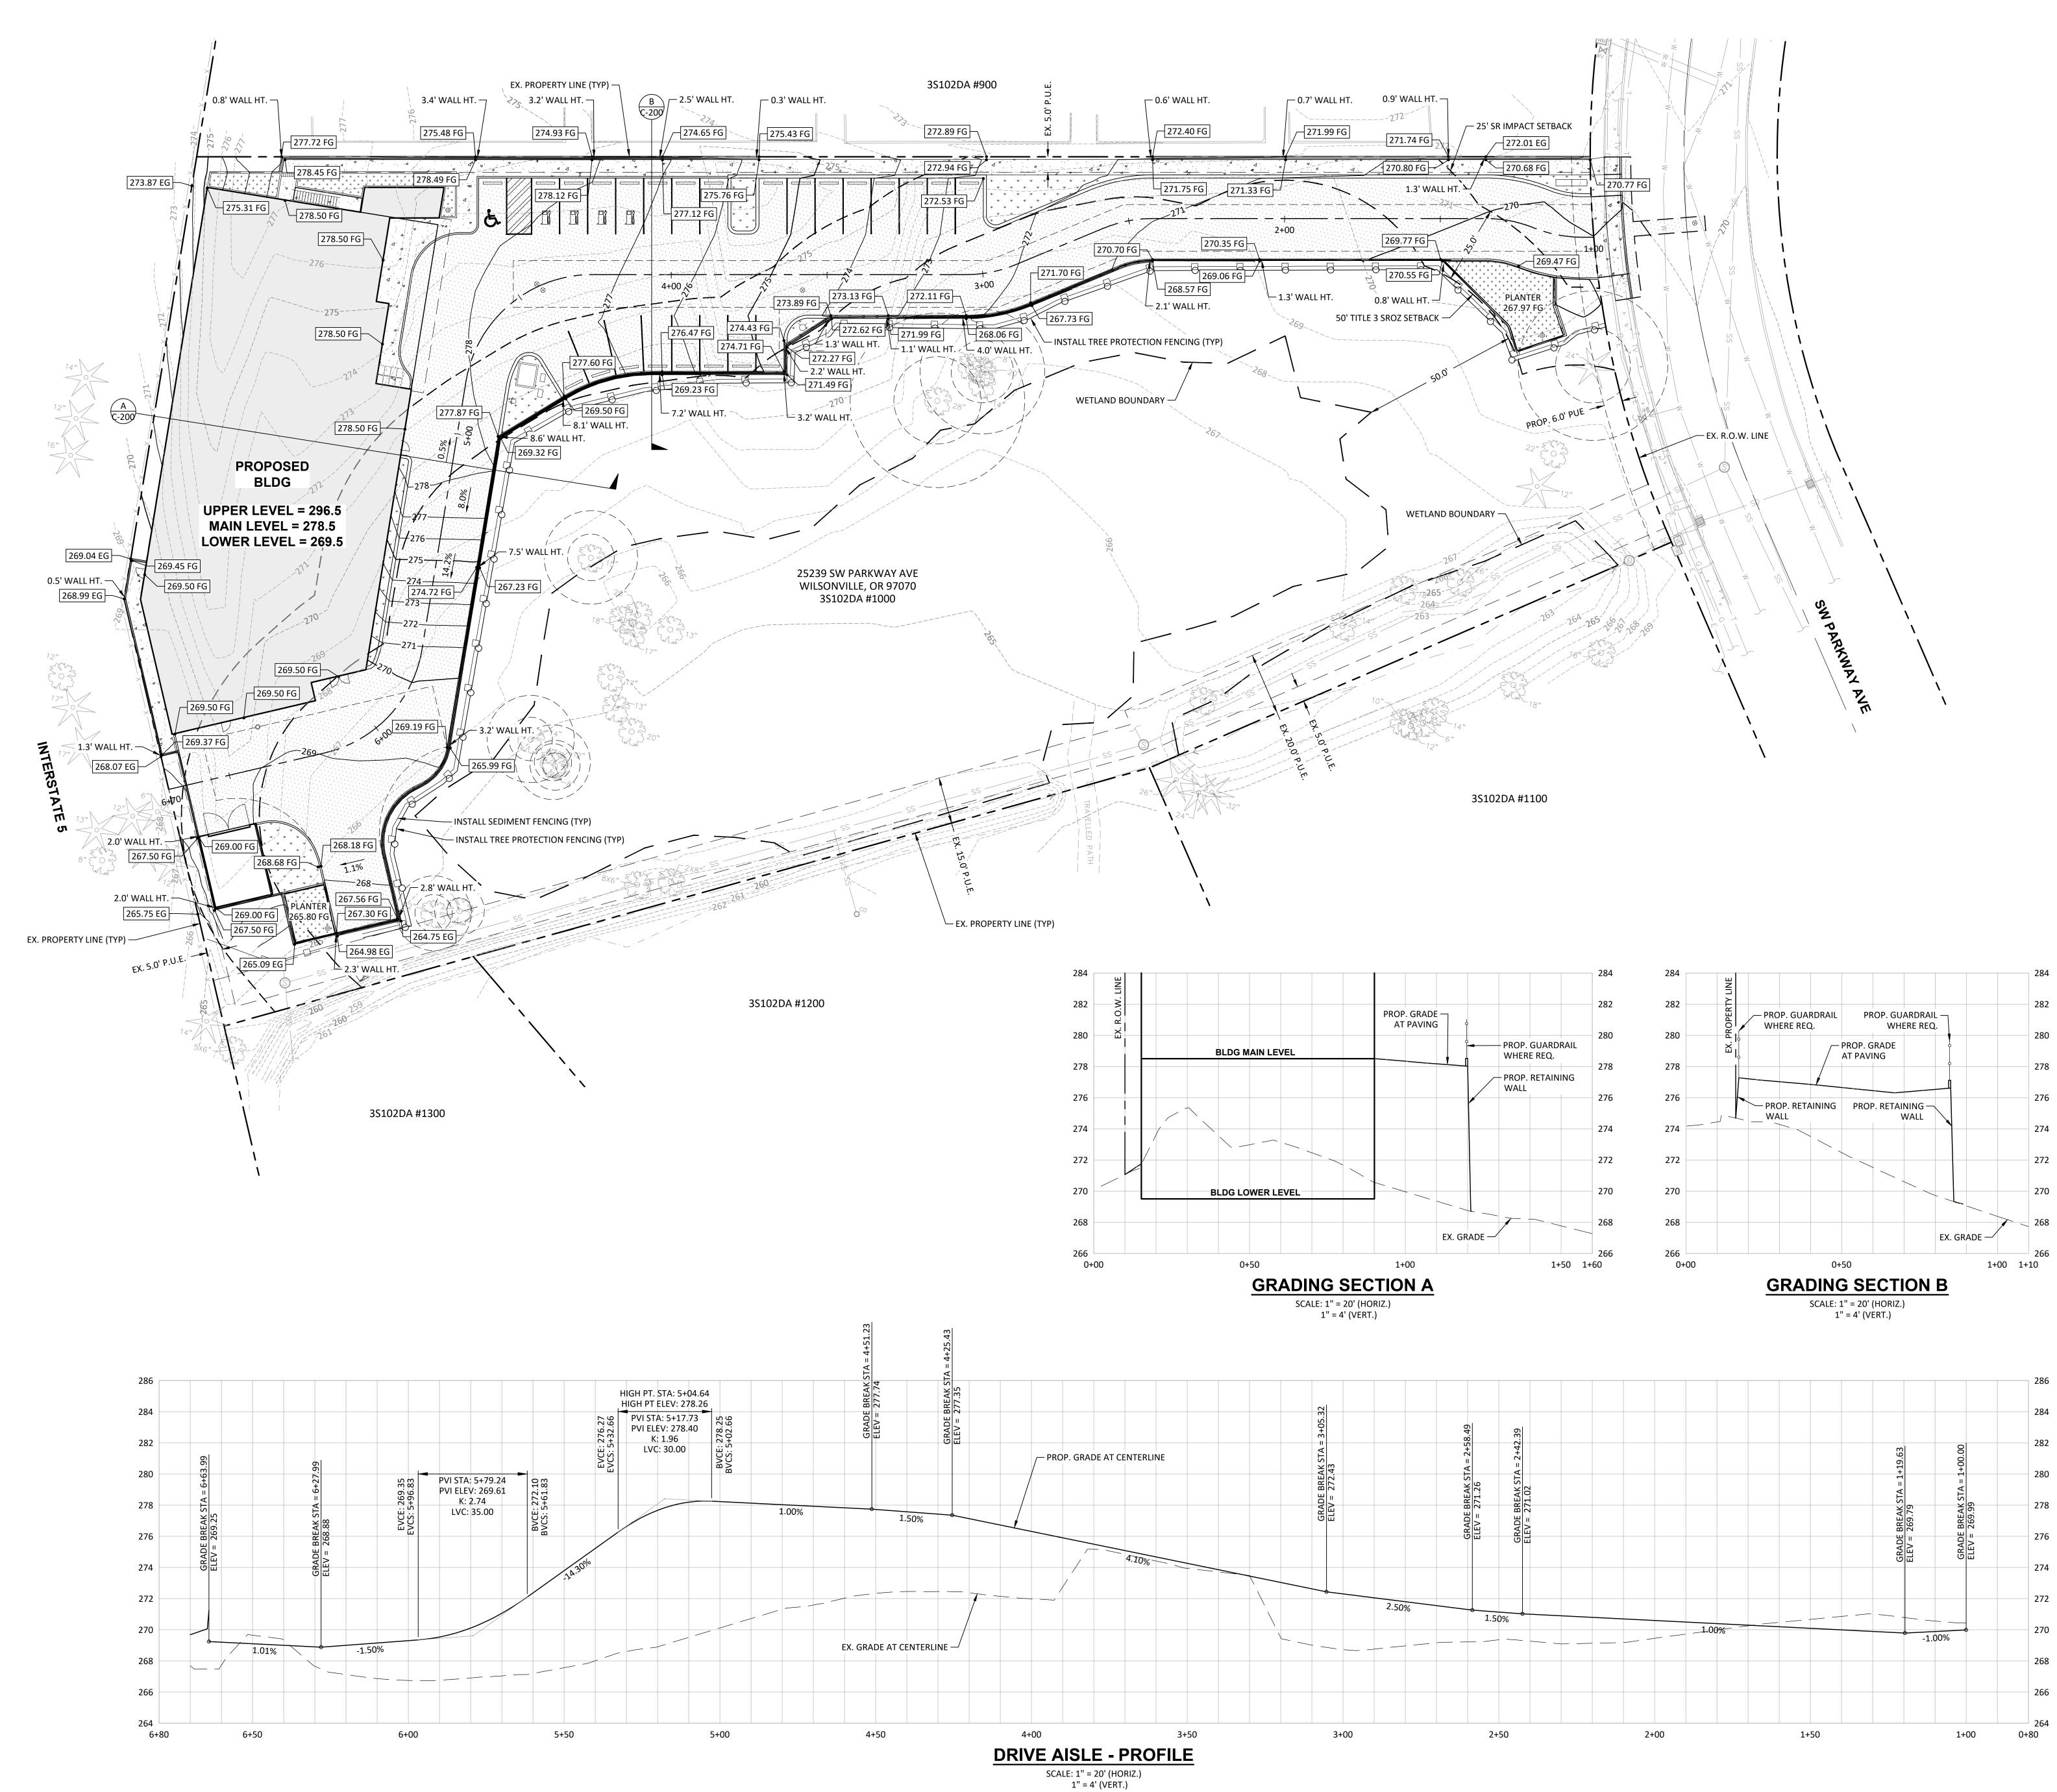
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DATE: 10/04/2024

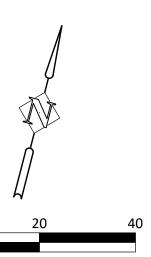ISSUED FOR: PRELIMINARY SHEET TITLE


PRELIMINARY CIVIL SITE PLAN








SCALE: 1" = 20'

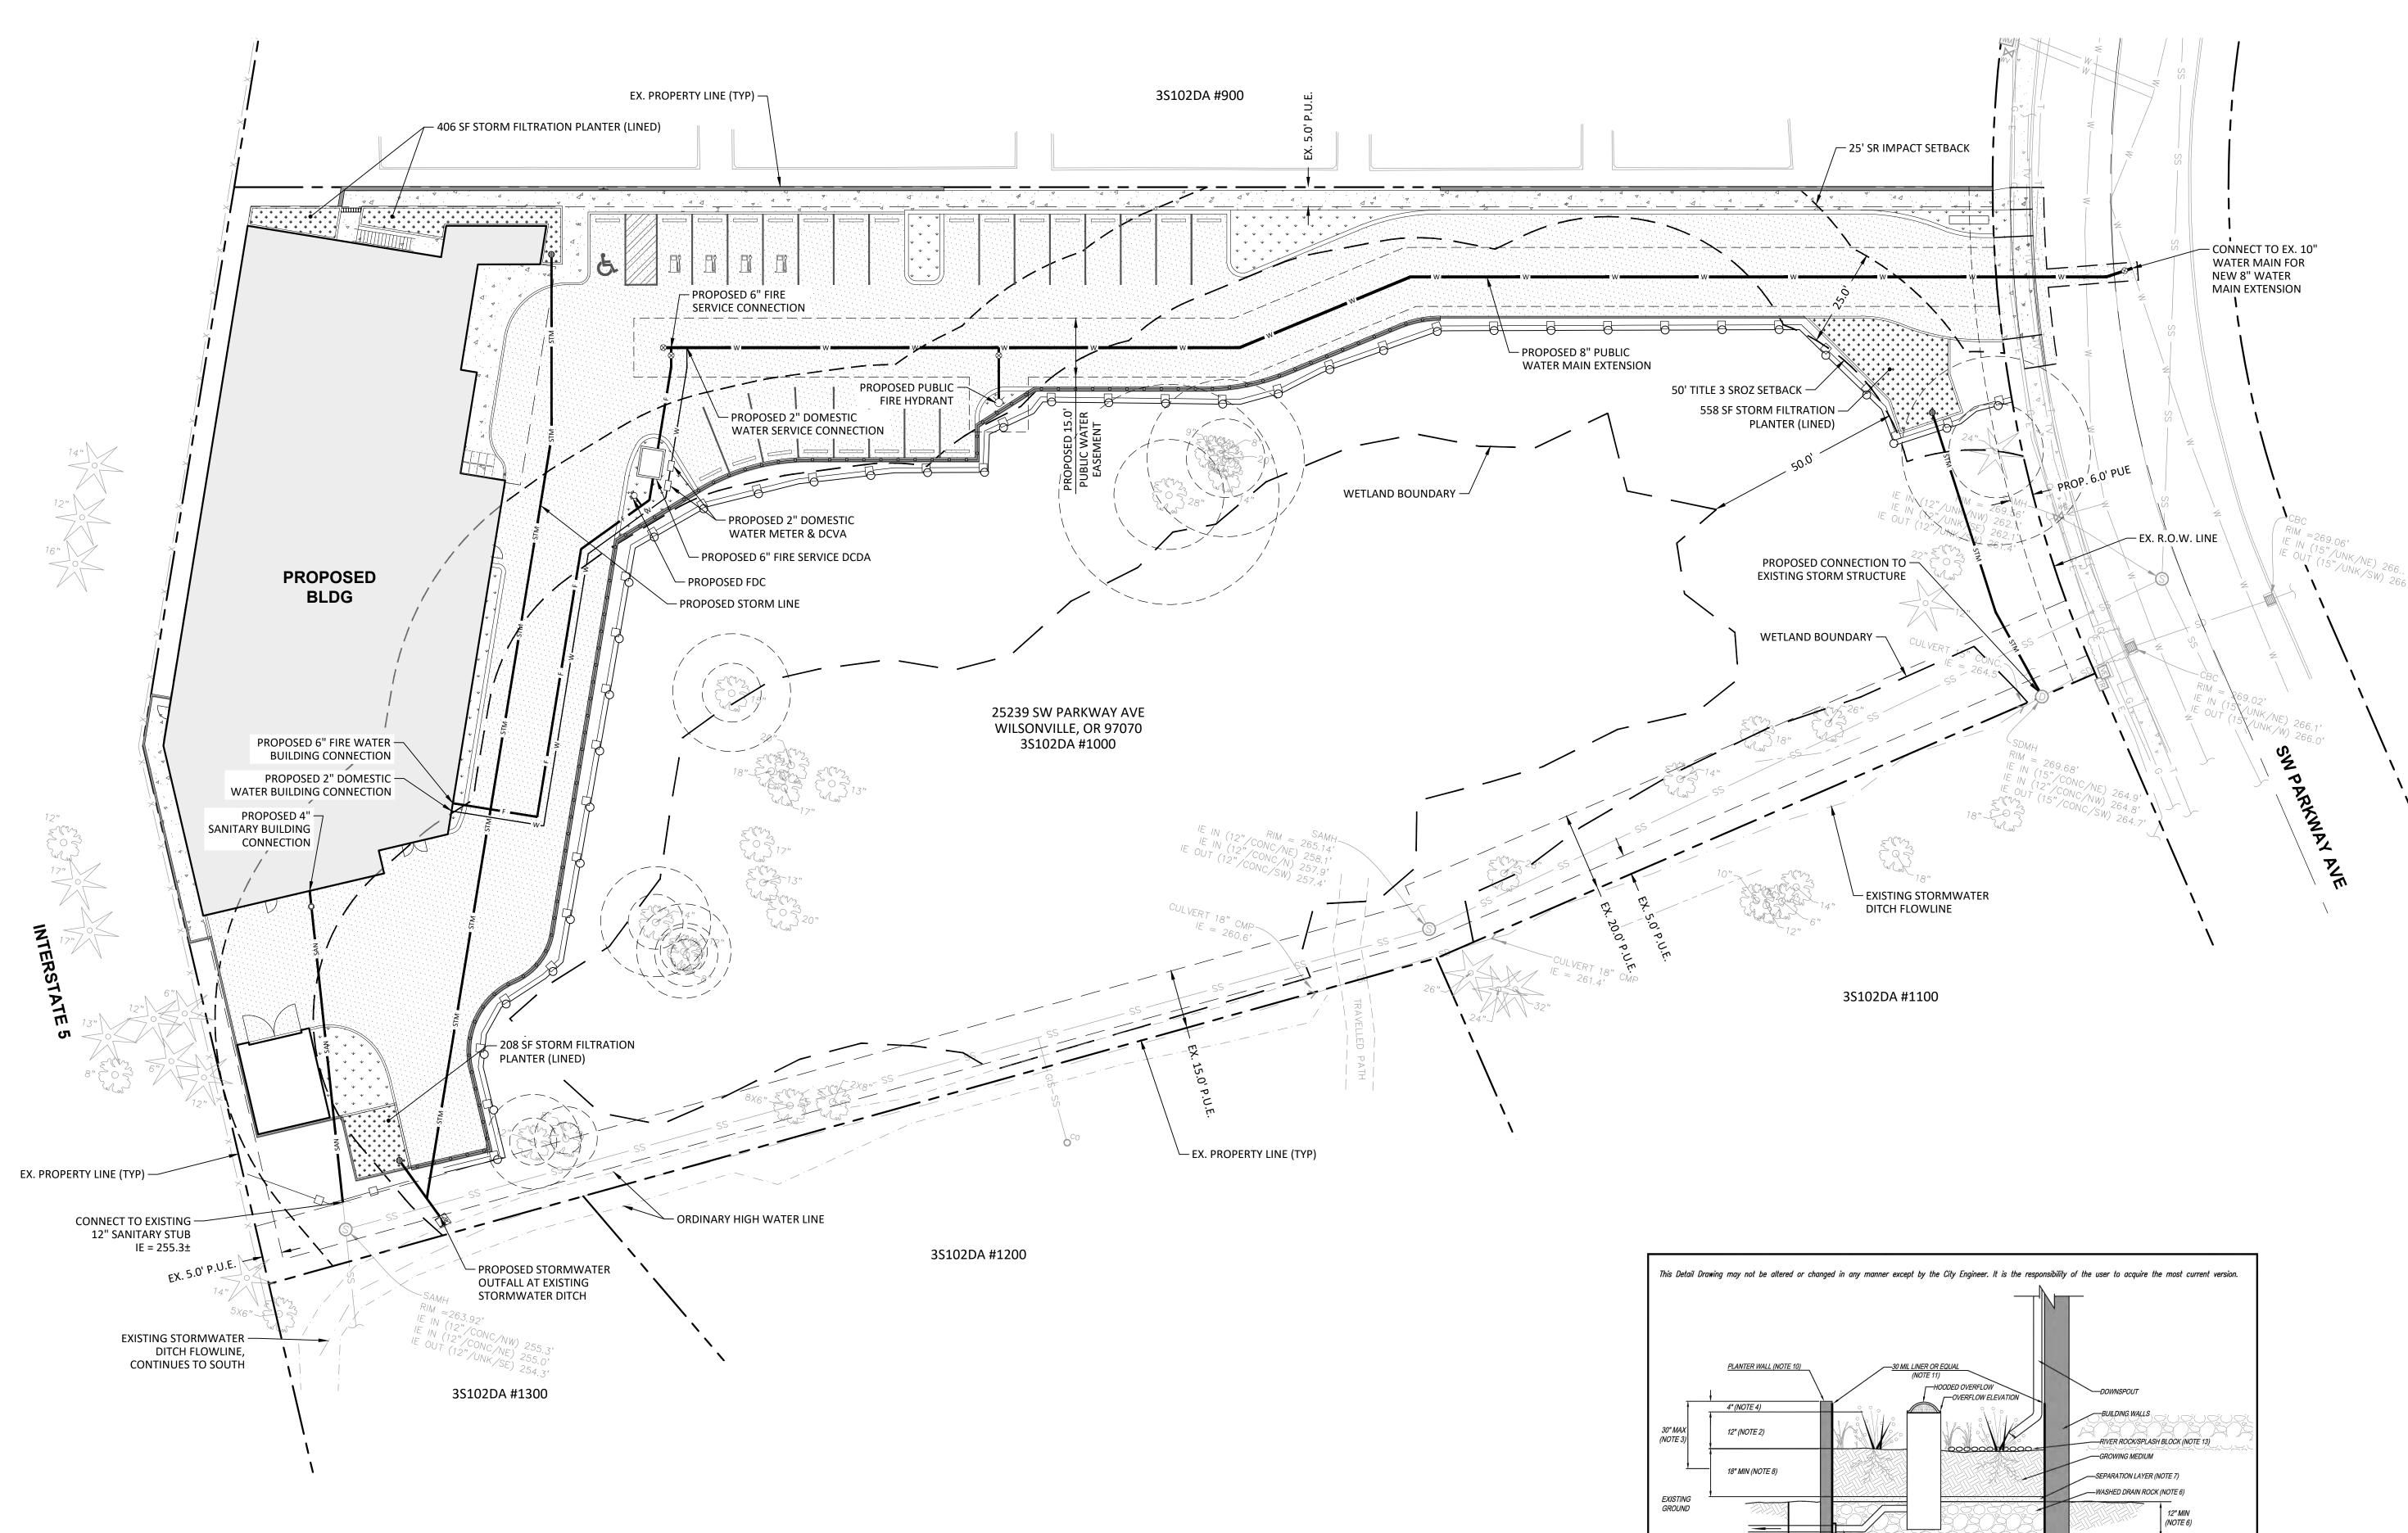

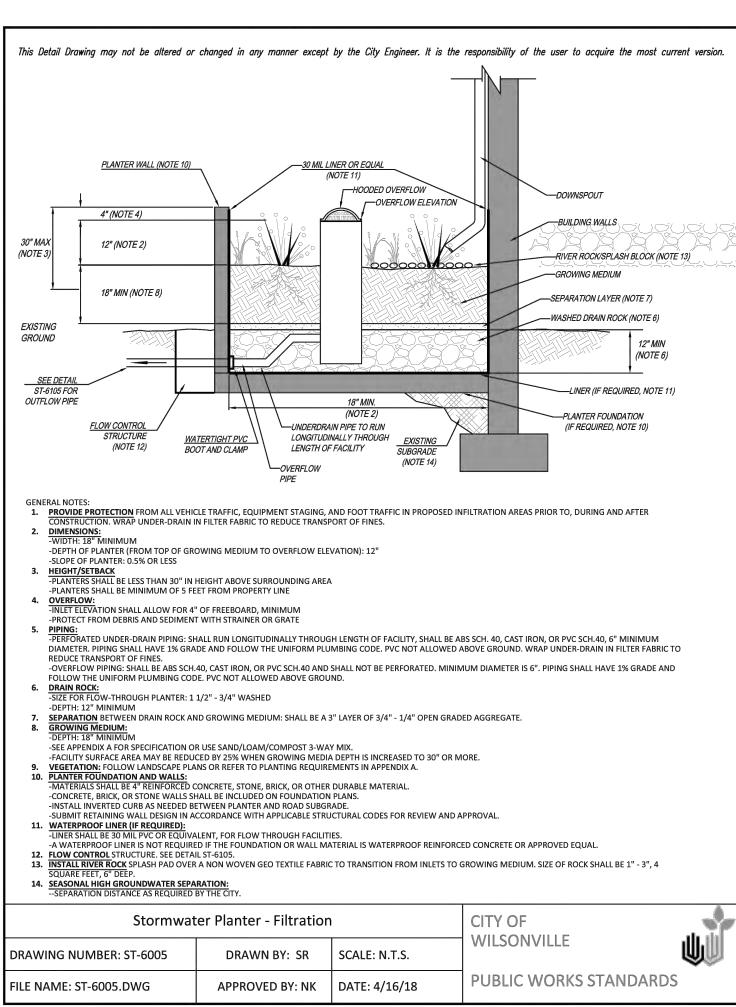


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PROPOSED SANITARY LINE PROPOSED STORM LINE PROPOSED WATER LINE PROPOSED FIRE WATER LINE PROPOSED FIRE DEPARTMENT CONNECTION (FDC) PROPOSED FIRE HYDRANT PROPOSED STORM PLANTER





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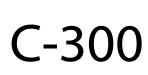
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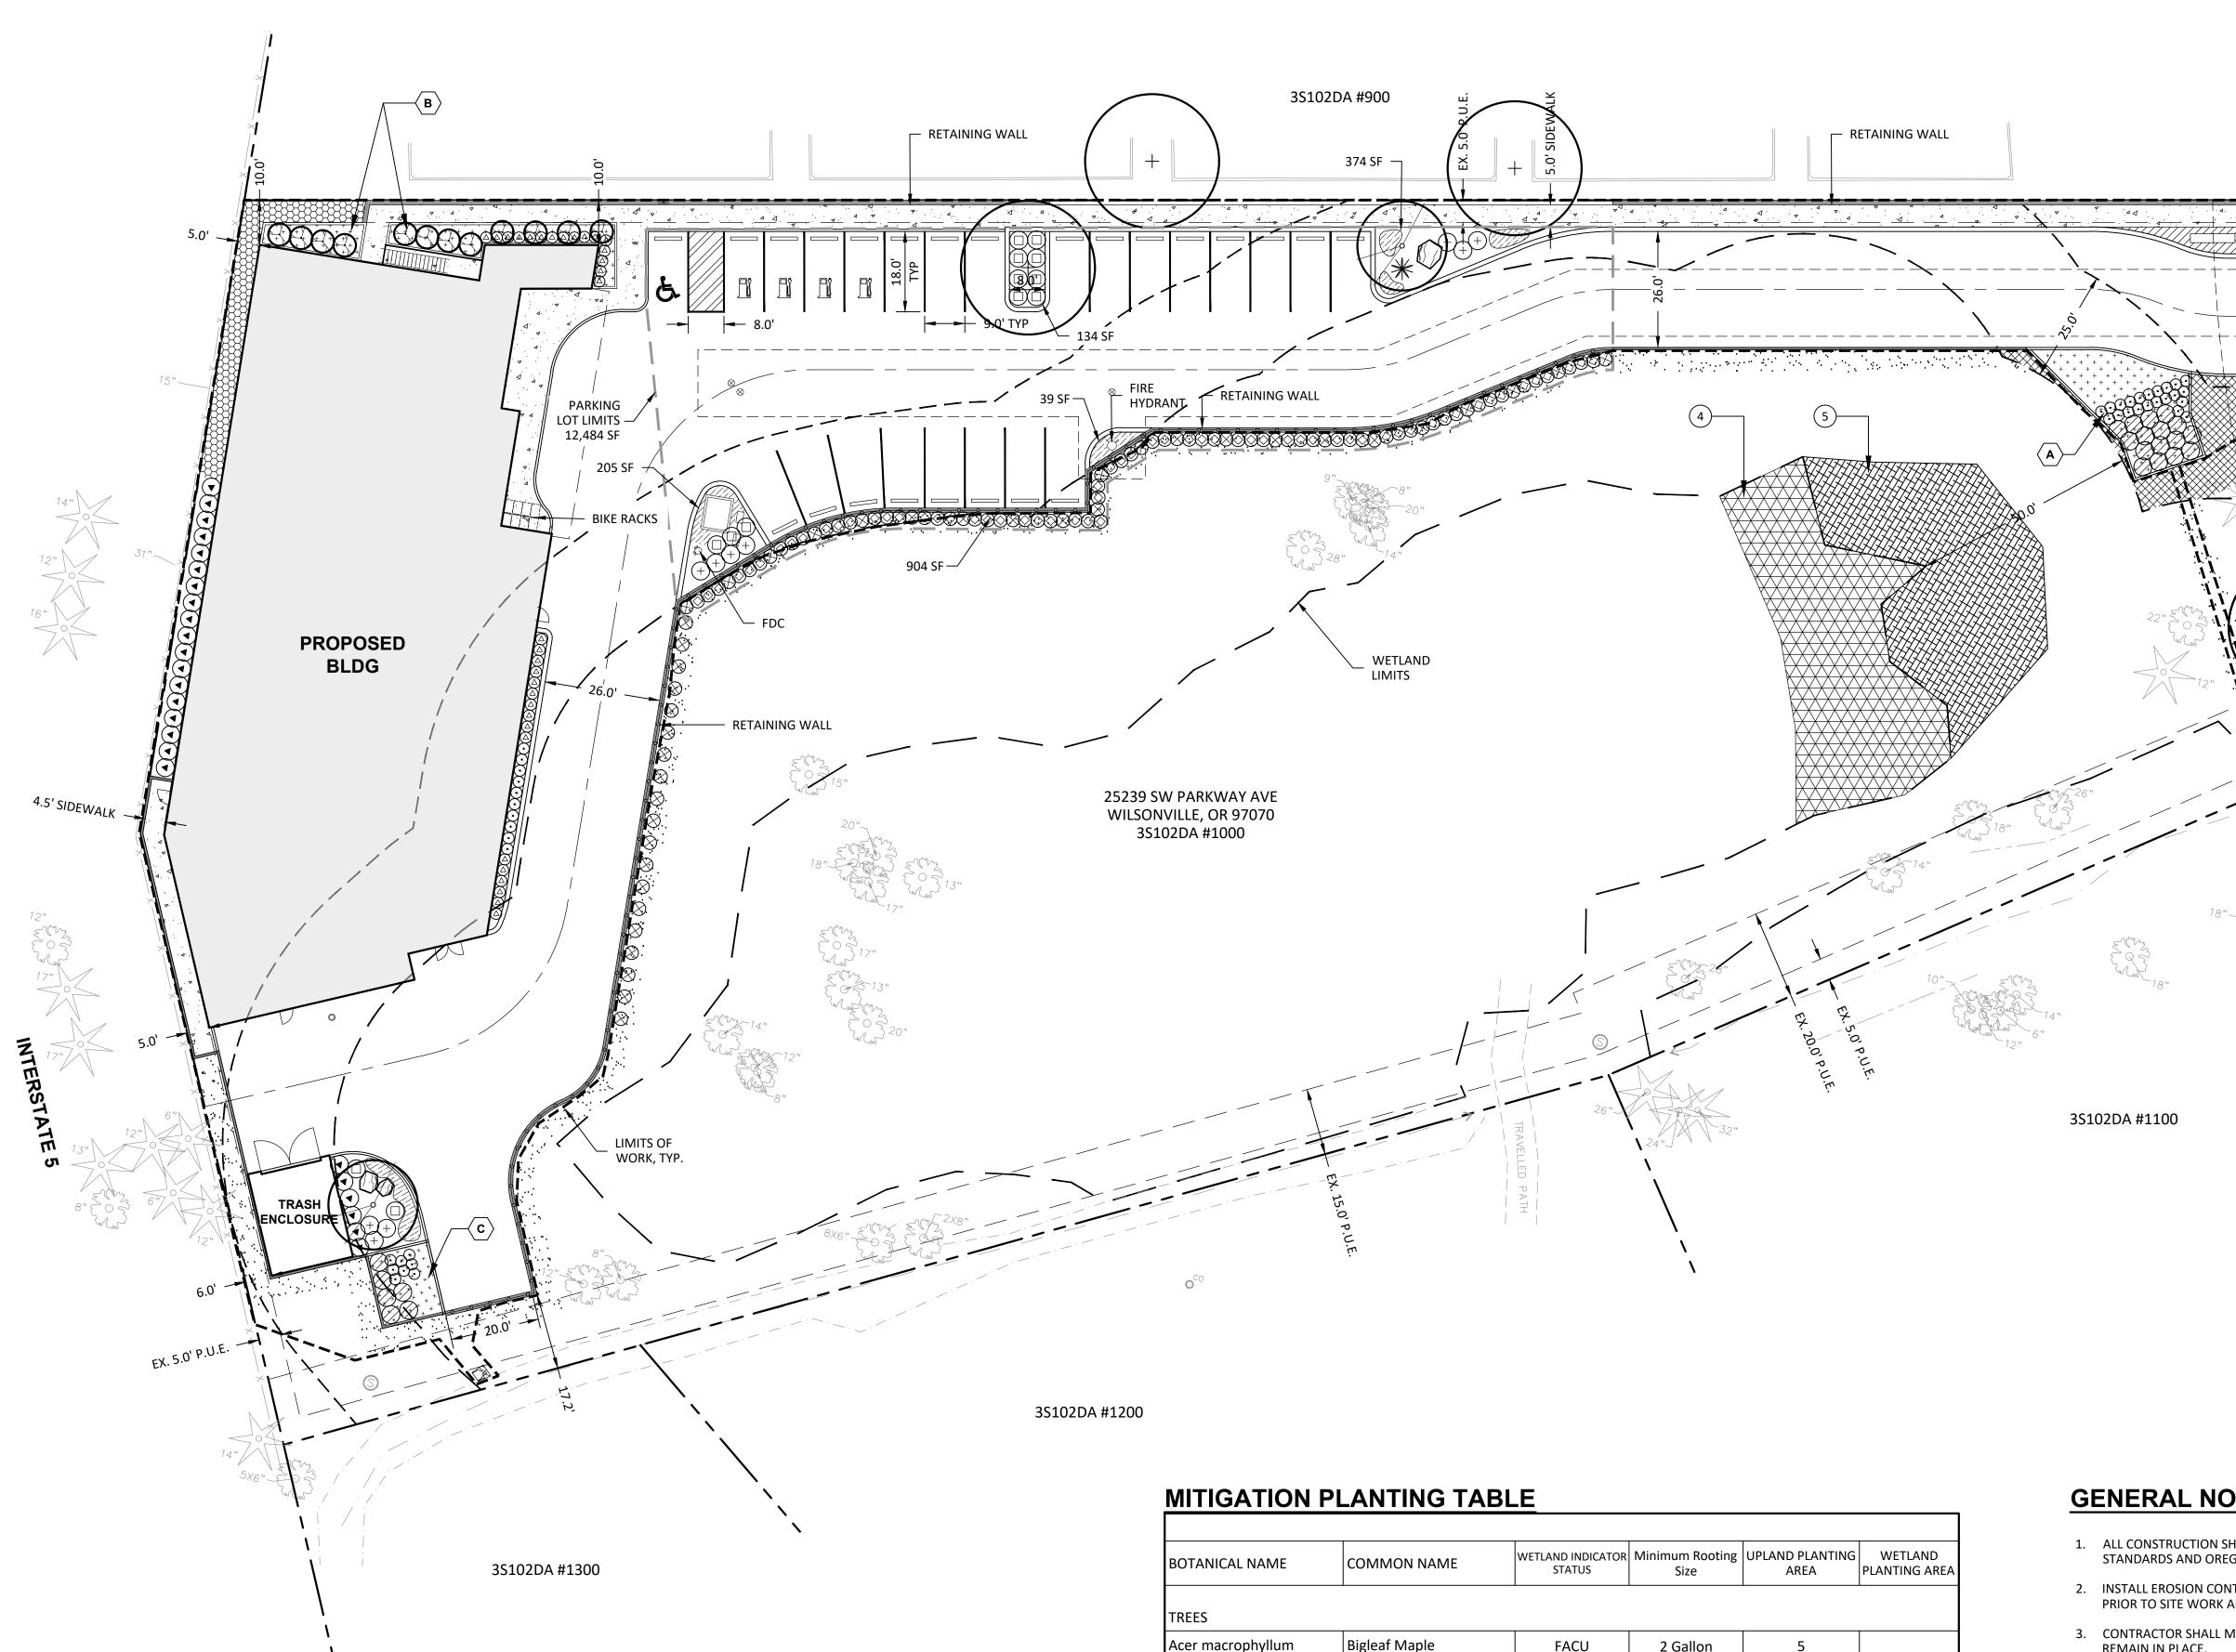
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DATE: 10/04/2024 ISSUED FOR: PRELIMINARY

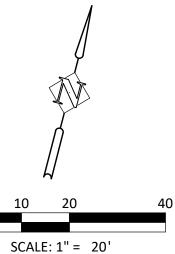SHEET TITLE PRELIMINARY UTILITY PLAN





STORM WATER FACILITY TABLE

				-		
BASIN NUMBER	SW FACILITY SF	SW FACILITY ZONE A	SW FACILITY ZONE B	TREES / LARGE SHURBS	SMALL SHRUBS	GROUNDCOVER
	558	558	0	17	22	642
B	406	406	0	12	16	467
C	208	208	0	6	8	239
TOTAL	1172	1172	0	35	46	1348


PLANNING NOTES

CITY OF WILSONVILLE CODE COMPIA	NCE
SITE AREA LANDSCAPE REQUIRED (15%)	100,284 SF 15,043 SF
LANDSCAPE PROVIDED: SROZ PARKING LOT LANDSCAPING SITE LANDSCAPING TOTAL (62%)	56,221 SF 2,172 SF <u>3,420 SF</u> 61,813 SF
PARKING LOT AREA LANDSCAPE REQUIRED (10%)	12,484 SF 1,248 SF
PARKING LOT LANDSCAPE PROVDED (13%)	1,617 SF
REQUIRED PL TREES (1 / 8 STALLS)	
24 STALLS = 3 TREES REQUIRED	

ZONE A : 3 LARGE SHUBS / SMALL TREES, 4 SMALL SHRUBS, 115 GROUND COVERS PLANTS (PER 100 SF)

BOTANICAL NAME	COMMON NAME	WETLAND INDICATOR STATUS	Minimum Rooting Size	UPLAND PLANTING AREA	WETLAND PLANTING AREA
TREES					
Acer macrophyllum	Bigleaf Maple	FACU	2 Gallon	5	
Quercus garryana	Oregon White Oak	UPL	2 Gallon	10	
Populus balsamilfera	Balsam Poplar	FAC	2 Gallon		5
Pinus ponderosa var. willamettensis	Willantte Valley Ponderosa Pine	FACU	2 Gallon	5	
Fraxinus latifolia	Oregon Ash	FACW	2 Gallon		15
			Total trees	20	20
SHRUBS				I	<u> </u>
Amelanchier alnifolia	Western Serviceberry	FACU	1 Gallon	5	
Symphorcarpus alba	Snowberry	FACU	1 Gallon	5	
Mahonia aquifollium	Tall Oregon Grape	UPL	1 Gallon	10	
Polystichum munitum	Pacifc Sword Fern	FACU	1 Gallon		
Cornus sericea ssp. sericea	Red-osier Dogwood	FACW	1 Gallon		5
Salix hookeriana	Hooker's Willow	FACW	1 Gallon		10
Spiraea douglasii	Douglas spirea	FACW	1 Gallon		5
		•	Total shrubs	20	20
GRASSES AND FORBS*					
Elymus glaucus	Blue Wild-rye	FACW	5 lbs		Х
Festuca idahoensis	Idaho Fescue	FACU	5 lbs	Х	

,284 SF ,043 SF 221 SF 172 SF 420 SF 813 SF ,484 SF 248 SF

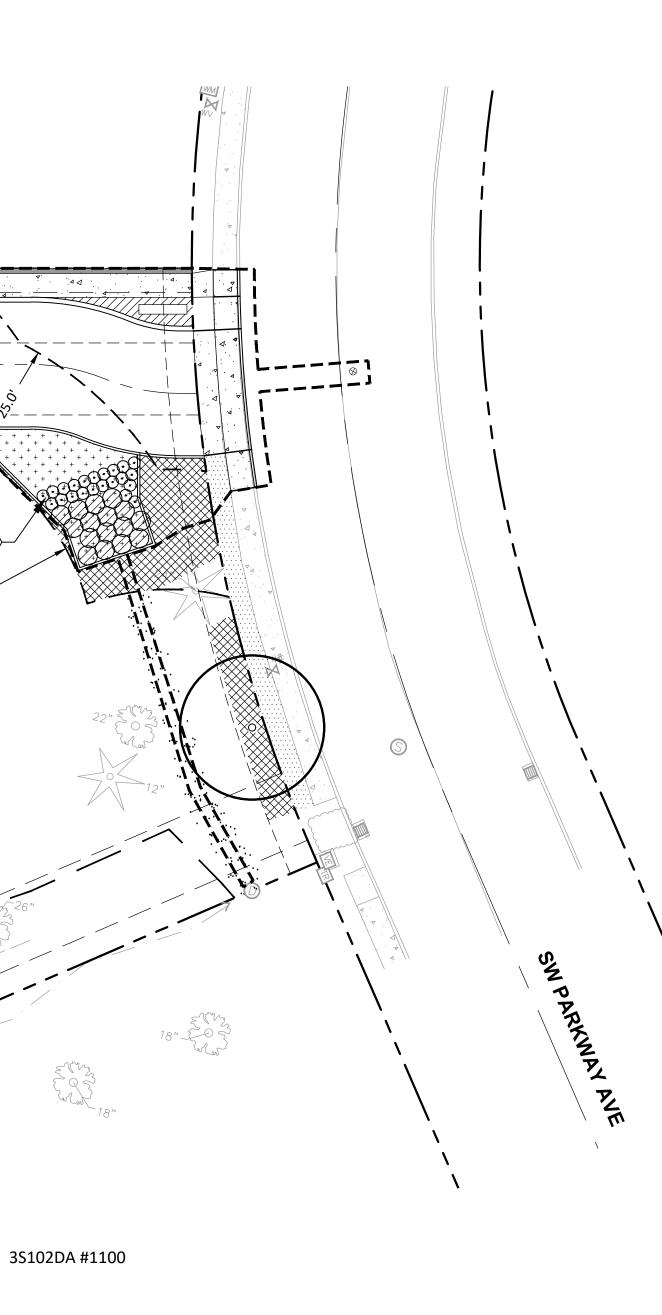

GENERAL NOTES:


FOR NURSERY STOCK" CURRENT EDITION.

- 1. ALL CONSTRUCTION SHALL BE PERFORMED IN ACCORDANCE WITH CURRENT CITY OF WILSONVILLE STANDARDS AND OREGON BUILDING AND SPECIALITY CODES. 2. INSTALL EROSION CONTROL SYSTEMS IN ACCORDANCE WITH CITY OF WILSONVILLE STANDARDS
- PRIOR TO SITE WORK AND LANDSCAPE INSTALLATION. 3. CONTRACTOR SHALL MARK AND PROTECT ALL UTILITIES, SITE FEATURES, AND VEGETATION TO REMAIN IN PLACE.
- 4. CONTRACTOR SHALL REMOVE ALL WEEDS AND INVASIVE SPECIES PRIOR TO PLANTING OR SEEDING. 5. ALL DISTURBED AREAS SHALL BE SEEDED.
- 6. PRIOR TO PLANTING, CONTRACTOR SHALL TEST ON-SITE SOILS FOR SOIL FERTILITY BY CERTIFIED TESTING LAB. IF NECESSARY, BACKFILL SOILS FOR TREE PITS, SHRUB AND GROUNDCOVER AREAS SHALL BE AMENDED AS RECOMMENDED BY SOIL ANALYSIS REPORT.
- 7. ALL SEEDED AREAS SHALL BE STRIPPED OF VEGETATION, SCARIFIED AND RECEIVE 4" OF TOPSOIL PRIOR TO APPLICATION OF SEED.
- 8. ALL PLANTER BEDS SHALL BE SCARIFIED 12" BELOW FINISHED GRADE AND HAVE 12" OF TOPSOIL ADDED TO BRING BACK TO FINISHED GRADE PRIOR TO PLANTING. 9. CONTRACTOR TO INSTALL 3" LAYER OF COMPOST MULCH AT ALL TREE, SHRUB AND GROUNDCOVER
- AREAS.
- 10. LANDSCAPE INSTALLATION SHALL INCLUDE PROVISION OF AN AUTOMATIC IRRIGATION SYSTEM TO SUSTAIN LANDSCAPE PLANTINGS, MEETING LOCAL AND STATE BUILDING CODES. 11. PLANT MATERIAL INSTALLED SHALL CONFORM IN SIZE AND GRADE TO THE "AMERICAN STANDARD
- 12. QUANTITIES OF PLANT MATERIALS SHALL BE AS DETERMINED BY CONTRACTOR IN ACCORDANCE WITH SPECIFIED SPACING OR LOCATION ON PLAN. MATERIAL QUANTITIES SHOWN ON PLAN ARE FOR CONTRACTOR CONVENIENCE ONLY AND SHALL BE VERIFIED BY CONTRACTOR PRIOR TO INSTALLATION. SURPLUS OR SHORTAGES OF PLANT QUANTITIES SHALL BE RESPONSIBILITY OF CONTRACTOR.
- 13. LANDSCAPE CONTRACTOR SHALL WATER PLANTINGS FOR DURATION OF 1-YEAR WARRANTY PERIOD AFTER INSTALLATION AND GUARANTEE ALL PLANTINGS TO BE IN SATISFACTORY HEALTH. LANDSCAPE CONTRACTOR SHALL REPLACE ALL DAMAGED, DEAD, OR DYING PLANTS COVERED BY WARRANTY WITHIN 30 DAYS OF INITIAL IDENTIFICATION OF CONDITION.

KEY NOTES

- (1) PLACE 12" AMENDED TOPSOIL IN SHRUB AREAS, TYP.
- (2) PLACE 3" BARK MULCH IN SHRUBS AREAS, TYP.
- (3) PLACE 6" AMENDED TOPSOIL IN SEEDED LAWN AREAS, TYP.
- (4) WETLAND MITIGATION PLANTINGS. SEE MITIGATION PLANTIGN DETAIL 6/L101 AND NOTES SHEET L101.
- 5 UPLAND MITIGATION PLANTINGS. SEE MITIGATION PLANTIGN TA DETAIL 6/L101 AND NOTES SHEET L101.

PLANT SCHEDULE

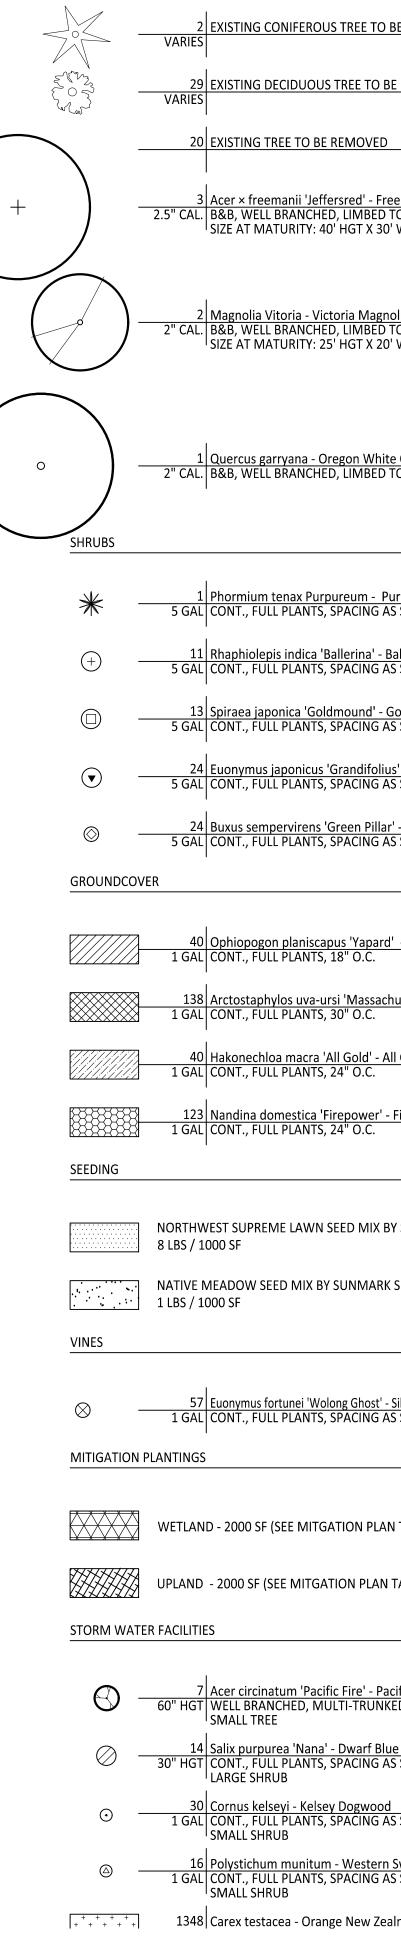

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	JEFFERY P. CREEL
	JEFFERY P. CREEL OREGON 05/13/11 PE ARCHI
I TABLE,	© AXIS DESIGN GROUP THESE DRAWINGS ARE THE PROPERTY DESIGN GROUP AND ARE NOT TO BE REPR IN ANY MANNER EXCEPT WITH THE PRIOR APPROVAL OF AXIS DESIGN GROUP.
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BE RETAINED	DESIGNGROU ARCHITECTURE & ENGINEERING,
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	T: 503.284.0988 F: 503.546.9
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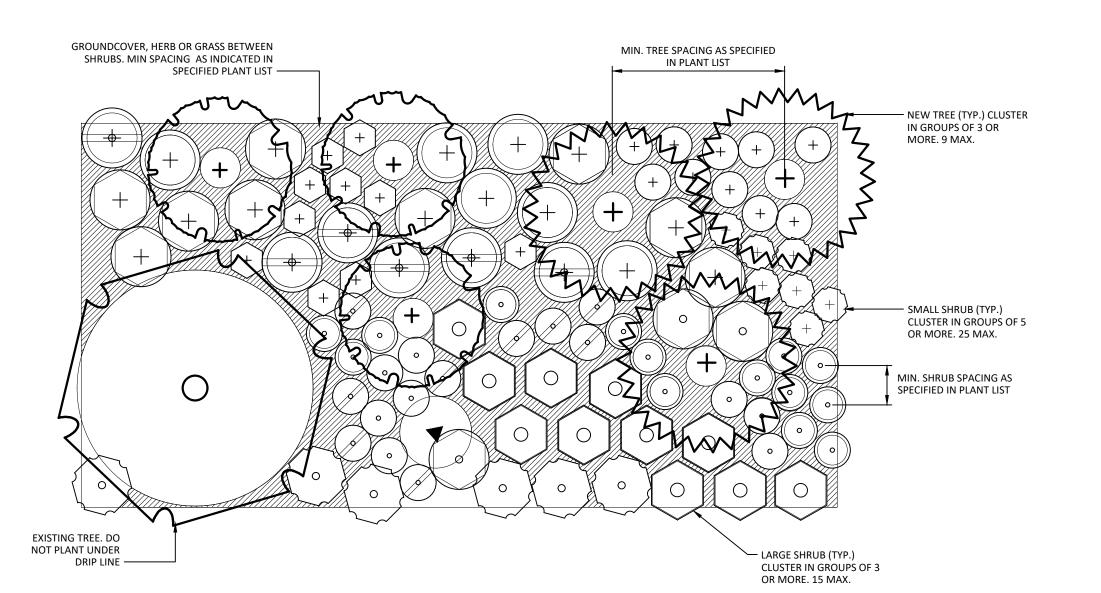


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TYPICAL MITIGATION PLANTING $(6)^{11}$

MITIGATION PLANTING NOTES:

- PLANTING METHODS, QUANTITIES AND PLACEMENT
- 1. DEEP ROOTING TREES AND SHRUBS SHALL NOT BE PLANTED ON TOP OF CONCRETE PIPES OR WITHIN 10 FEET OF RETAINING WALLS, INLET/OUTLET STRUCTURES OR OTHER CULVERTS.
- 2. LARGE TREES OR SHRUBS SHALL NOT BE PLANTED ON BERMS OVER 4 FEET TALL THAT IMPOUND WATER. SMALL TREES OR SHRUBS WITH FIBROUS ROOT SYSTEMS MAY BE INSTALLED ON BERMS THAT IMPOUND WATER AND ARE LESS THAN 4 FEET TALL.
- 3. CONTAINERIZED STOCK SHALL BE INSTALLED ONLY FROM FEBRUARY 1 THROUGH MAY 1 AND OCTOBER 1 THROUGH NOVEMBER 15. IF PLANTING OUTSIDE OF THESE TIMES IS PROPOSED, CONTRACTOR SHALL SUBMIT PROCEDURES OF ADDITIONAL MEASURES TO BE IMPLEMENTED TO ENSURE SURVIVAL.
- ACCESS, MONITORING AND MAINTENANCE 1. CONTRACTOR SHALL PROVIDE
- MONITORING AND MAINTENANCE FOR A PERIOD OF 2 YEARS FOLLOWING SUBSTANTIAL COMPLETION AND ACCEPTANCE.
- 2. CONTRACTOR SHALL SUBMIT MAINTENANCE SCHEDULE, INCLUDING RESPONSIBLE PARTY, CONTACT INFORMATION, DATES OF INSPECTION (MINIMUM 3 PER GROWING SEASON, AND ONE PRIOR TO ONSET OF GROWING SEASON) AND ESTIMATED MAINTENANCE SCHEDULE THROUGHOUT THE 2-YEAR MONITORING PERIOD.
- 3. CONTRACTOR SHALL INSPECT THE SITE WITH PROJECT ENGINEER OR OWNER'S REPRESENTATIVE DURING SCHEDULED SITE VISITS. PLANTINGS SHALL BE EVALUATED AND REPLACED AS NECESSARY TO ENSURE A MINIMUM 80% SURVIVAL RATE OF THE INSTALLATION AND 90% AERIAL COVERAGE.
- 4. NON-NATIVE, INVASIVE PLANT SPECIES SHALL BE REMOVED WHEN OCCUPYING GREATER THAN 20% OF THE SITE.

1. TREES, SHRUBS AND GROUNDCOVERS PLANTED IN UPLAND AREAS SHALL BE MULCHED A MINIMUM 3" DEPTH AND 18" DIAMETER. APPROPRIATE MULCHES SHALL BE DERIVED FROM COMPOSTED BARK OR LEAVES THAT HAVE NOT

BEEN CHEMICALLY TREATED.

MULCHING AND IRRIGATION

ORGANIC MULCH SHALL NOT BE USED IN FREQUENTLY INUNDATED AREAS (SWALE TREATMENT AREA). 2. CONTRACTOR SHALL SUBMIT SUPPLEMENTAL WATERING PLAN FOR APPROVAL BY CITY. CONTRACTOR SHALL WATER FOR A MINIMUM 2-YEAR PLANT ESTABLISHMENT PERIOD. WATERING SHALL BE A MINIMUM RATE OF 1 INCH PER WEEK FROM

JUNE 15 THROUGH OCTOBER 15.

- EROSION CONTROL 1. INSTALL AND/OR MAINTAIN EROSION CONTROL SYSTEMS IN ACCORDANCE WITH CITY OF WILSONVILLE & CLACKAMAS COUNTY STANDARDS PRIOR TO SITE WORK AND LANDSCAPE INSTALLATION.
- 2. GRADING, SOIL PREPARATION, AND SEEDING SHALL BE PERFORMED DURING OPTIMAL WEATHER CONDITIONS AND AT LOW FLOW LEVELS TO MINIMIZE SEDIMENT IMPACTS.
- 3. SITE DISTURBANCE SHALL BE MINIMIZED AND DESIRABLE NATIVE VEGETATION RETAINED WHERE POSSIBLE.
- 4. PLASTIC MESH THAT CAN ENTANGLE WILDLIFE IS NOT PERMITTED. WWTLAND PLANTING GENERAL NOTES
- 1. ALL INVASIVE, NON-NATIVE OR NOXIOUS PLANT MATERIAL IS TO BE REMOVED. THE SUBJECT SITE IS TO EMPLOY MANUAL/MECHANICAL MANAGEMENT STRATEGIES AND PESTICIDE MANAGEMENT STRATEGIES THROUGHOUT MAINTENANCE PERIOD OR UNTIL HEALTHY STAND OF DESIRABLE VEGETATION IS ESTABLISHED.
- 2. PRESERVE SITE'S EXISTING NATIVE VEGETATION TO THE MAXIMUM EXTENT PRACTICABLE. EVERY EFFORT SHALL BE MADE TO PROTECT A SITE'S EXISTING NATIVE VEGETATION. NATIVE VEGETATION ALONG SENSITIVE

AREAS AND VEGETATED CORRIDORS SHALL BE RETAINED TO THE MAXIMUM EXTENT PRACTICABLE

- 3. REPLANTING/ENHANCEMENT AS FOLLOWS:
- PLAN FOR PLANT SPECIES, LOCATION, DISTRIBUTION, QUANTITIES, SIZE, CONDITION AND REQUIREMENTS. ALL PLANTS TO BE PIT PLANTED WITH ADDITIONAL ORGANIC MATTER IF **REQUIRED BUT NO TRADITIONAL** FERTILIZER IS NECESSARY. PLANT PLACEMENT SHALL BE CONSISTENT WITH THE FORM OF THE NATURALLY OCCURRING PLANT COMMUNITY. SHRUBS SHALL BE PLACED IN SINGLES OR CLUSTERS OF THE SAME SPECIES TO PROVIDE A NATURAL PLANTING SCHEME.
- 4. PLANT INSTALLATION REQUIREMENTS. THE CONTRACTOR IS RESPONSIBLE FOR INSTALLATION OF SITE PLANTING AS SPECIFIED. ALL TREES AND SHRUBS PLANTED IN THE UPLAND AREA ARE TO BE MULCHED A MINIMUM OF THREE INCHES IN DEPTH AND 18 INCHES IN DIAMETER. APPROPRIATE MULCHES INCLUDE THOSE MADE FROM COMPOSTED LEAVES OR BARK THAT HAVE NOT BEEM CHEMICALLY TREATED. TEMPORARY IRRIGATION WILL BE PROVIDED AND USED DURING THE TWO YEAR MAINTENANCE

PERIOD.

- 5. MONITORING AND MAINTENANCE. CONTRACTOR IS RESPONSIBLE FOR MONITORING AND MAINTAINING THE SITE. ALL NEW PLANT MATERIAL IS TO BE TAGGED. THE REMOVAL OF NON-NATIVE, INVASIVE WEEDS IS NECESSARY THROUGHOUT THE TWO YEAR MAINTENANCE PERIOD, OR UNTIL A HEALTHY STAND OF DESIRABLE VEGETATION IS ESTABLISHED. THE SITE IS TO BE MONITORED A MIN. OF 4 TIMES PER YEAR, OR 3 TIMES PER GROWING SEASON. IF AT ANY TIME THE LANDSCAPING FALLS BELOW THE 80% SURVIVAL LEVEL, THE CONTRACTOR SHALL **REINSTALL ALL DEFICIENT** PLANTING AT THE NEXT APPROPRIATE OPPORTUNITY AND THE TWO YEAR MAINTENANCE PERIOD SHALL BEGIN AGAIN FROM THE DATE OF THE REPLANTING.
- 6. PLANT TIMING. CONTAINERIZED STOCK SHALL BE INSTALLED ONLY FROM FEBRUARY 1 THROUGH MAY 1 AND OCTOBER 1 THROUGH

REFER TO PLANT TABLE, DETAILS AND

NOVEMBER 15. BARE ROOT STOCK SHALL BE INSTALLED ONLY FROM DECEMBER 15 THROUGH APRIL 15. PLANTINGS OUTSIDE THESE TIMES MAY REQUIRE ADDITIONAL MEASURES TO ENSURE SURVIVAL WHICH SHALL BE SPECIFIED ON THE PLANS.

Scale: 1"-8'-0"


SITE PREPARATION


- 1. CONTRACTOR SHALL REMOVE ALL WEEDS AND INVASIVE SPECIES PRIOR TO PLANTING. ALL SEEDED AREAS SHALL BE STRIPPED OF VEGETATION, SCARIFIED AND RECEIVE 4" OF TOPSOIL PRIOR TO APPLICATION OF SEED.
- 2. FOR UPLAND SITES WITH AT LEAST ONE FOOT OF NATIVE TOPSOIL, BUT CONTAINING A NON-NATIVE, INVASIVE SEED BANK OR PLANTS, REMOVE THE UNDESIRABLE PLANTS, ROOTS, AND SEEDS PRIOR TO PLANTING.
- 3. ALL TREE AND SHRUB PLANTING AREAS SHALL BE SCARIFIED 12" BELOW FINISHED GRADE AND HAVE 12" OF TOPSOIL ADDED TO BRING BACK TO FINISHED GRADE PRIOR TO PLANTING.
- 4. FOR UPLAND SITES WITH EITHER DISTURBED AND COMPACTED SOILS OR LESS THAN ONE FOOT OF TOPSOIL AND INVIASIVE, NON-NATIVE SEED BANK OR PLANTS THAT HAVE BECOME ESTABLISHED:
- 4.1. REMOVE UNDESIRABLE PLANTS, ROOTS, AND SEEDS PRIOR TO ADDING TOPSOIL.
- 4.2. TILL SUB-GRADE IN THESE AREAS TO DEPTH OF AT LEAST FOUR INCHES AND ADD 12" MINIMUM CLEAN COMPOST-AMENDED TOPSOIL. COMPOST AMENDED TOPSOIL SHALL
- HAVE THE FOLLOWING CHARACTERISTICS: 4.2.1. TEXTURE: MATERIAL PASSES THROUGH 1-INCH SCREEN FERTILITY: 35% ORGANIC 4.2.2.
- MATTER 4.3. IN THE EVENT OF FLOODPLAIN
- GRADING, OVER-EXCAVATE SUB-GRADE TO ENSURE 12 INCHES OF TOPSOIL CAN BE APPLIED WITHOUT IMPACTING SURFACE WATER ELEVATIONS.
- 5. WHERE APPROPRIATE AND NECESSARY FOR EROSION CONTROL OR TO ENHANCE ORGANIC MATTER. LEAF COMPOST MAY BE PLACED UNIFORMLY ON TOPSOIL. OTHER AMENDMENTS, CONDITIONERS, AND BIO-AMENDMENTS MAY BE ADDED AS NEEDED TO SUPPORT


SPECIFIED PLANTS OR ADJUST SOIL pH. CONVENTIONAL FERTILIZERS (N-P-K) SHALL NOT BE USED FOR NATIVE PLANTINGS.

MAINTENANCE

1. CONTRACTOR SHALL PROVIDE MONITORING AND MAINTENANCE OF MITIGATION PLANTINGS AND VEGETATED CORRIDOR FOR A PERIOD OF 2 YEARS FOLLOWING SUBSTANTIAL COMPLETION AND ACCEPTANCE.

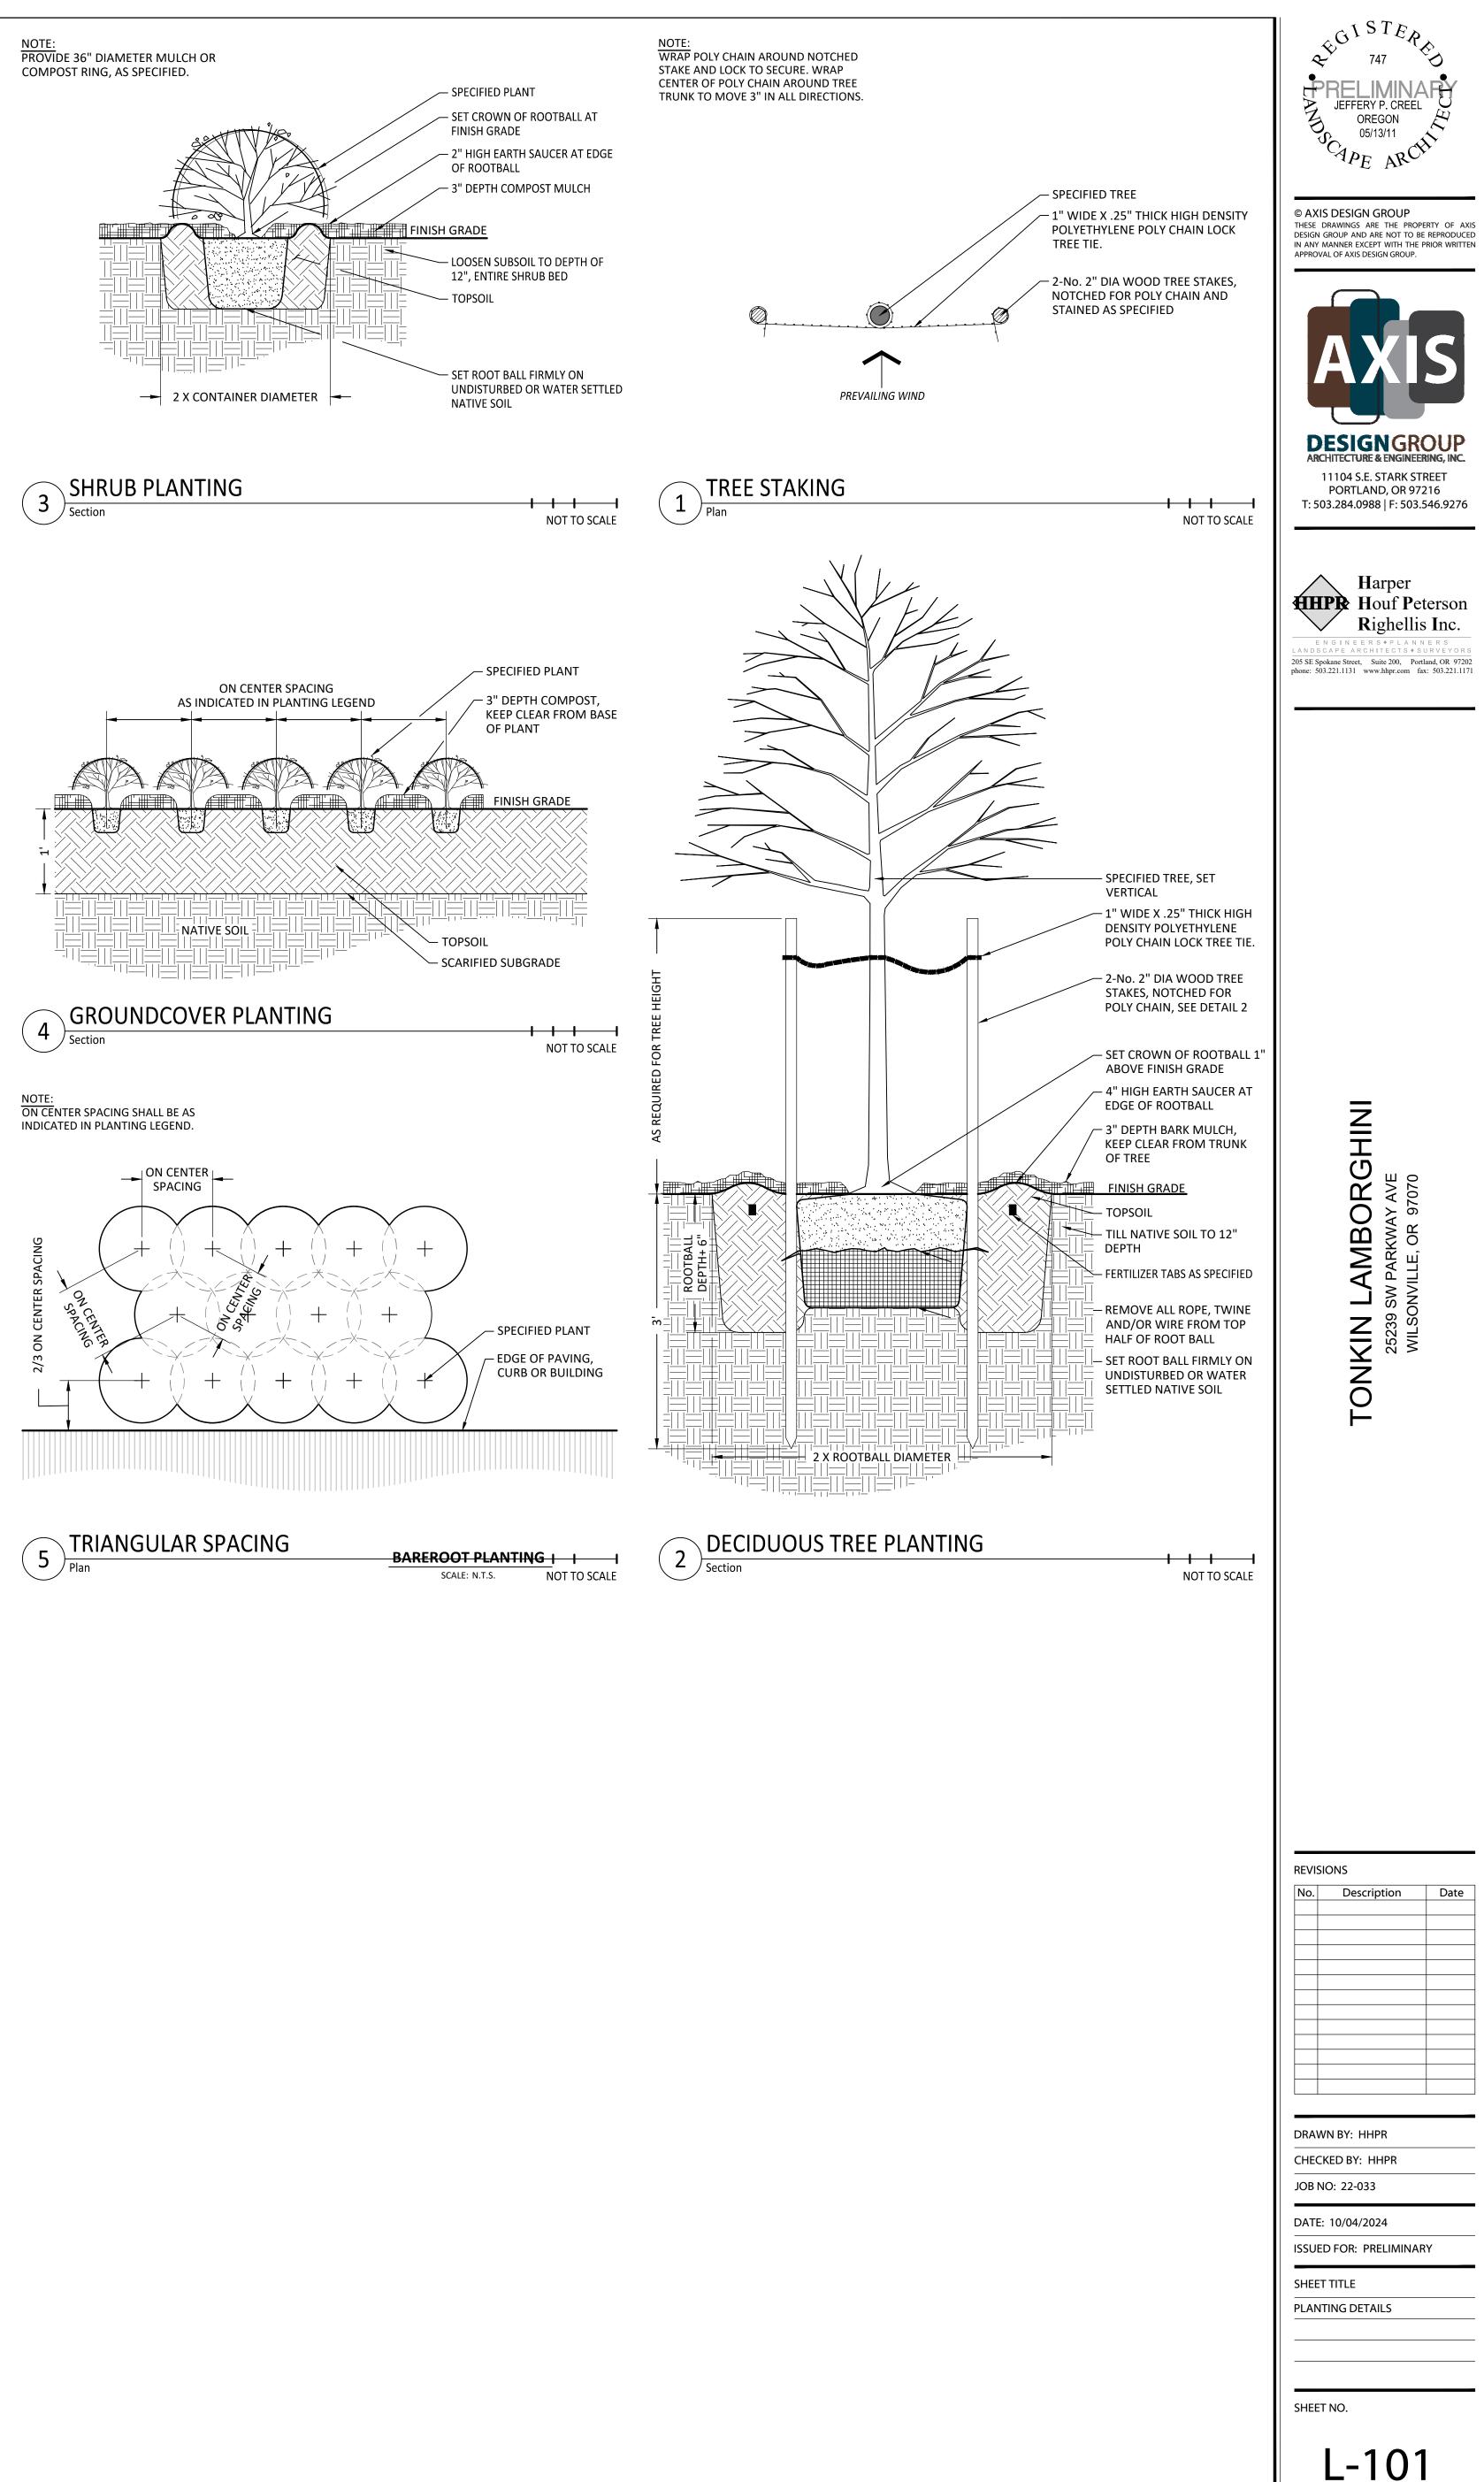

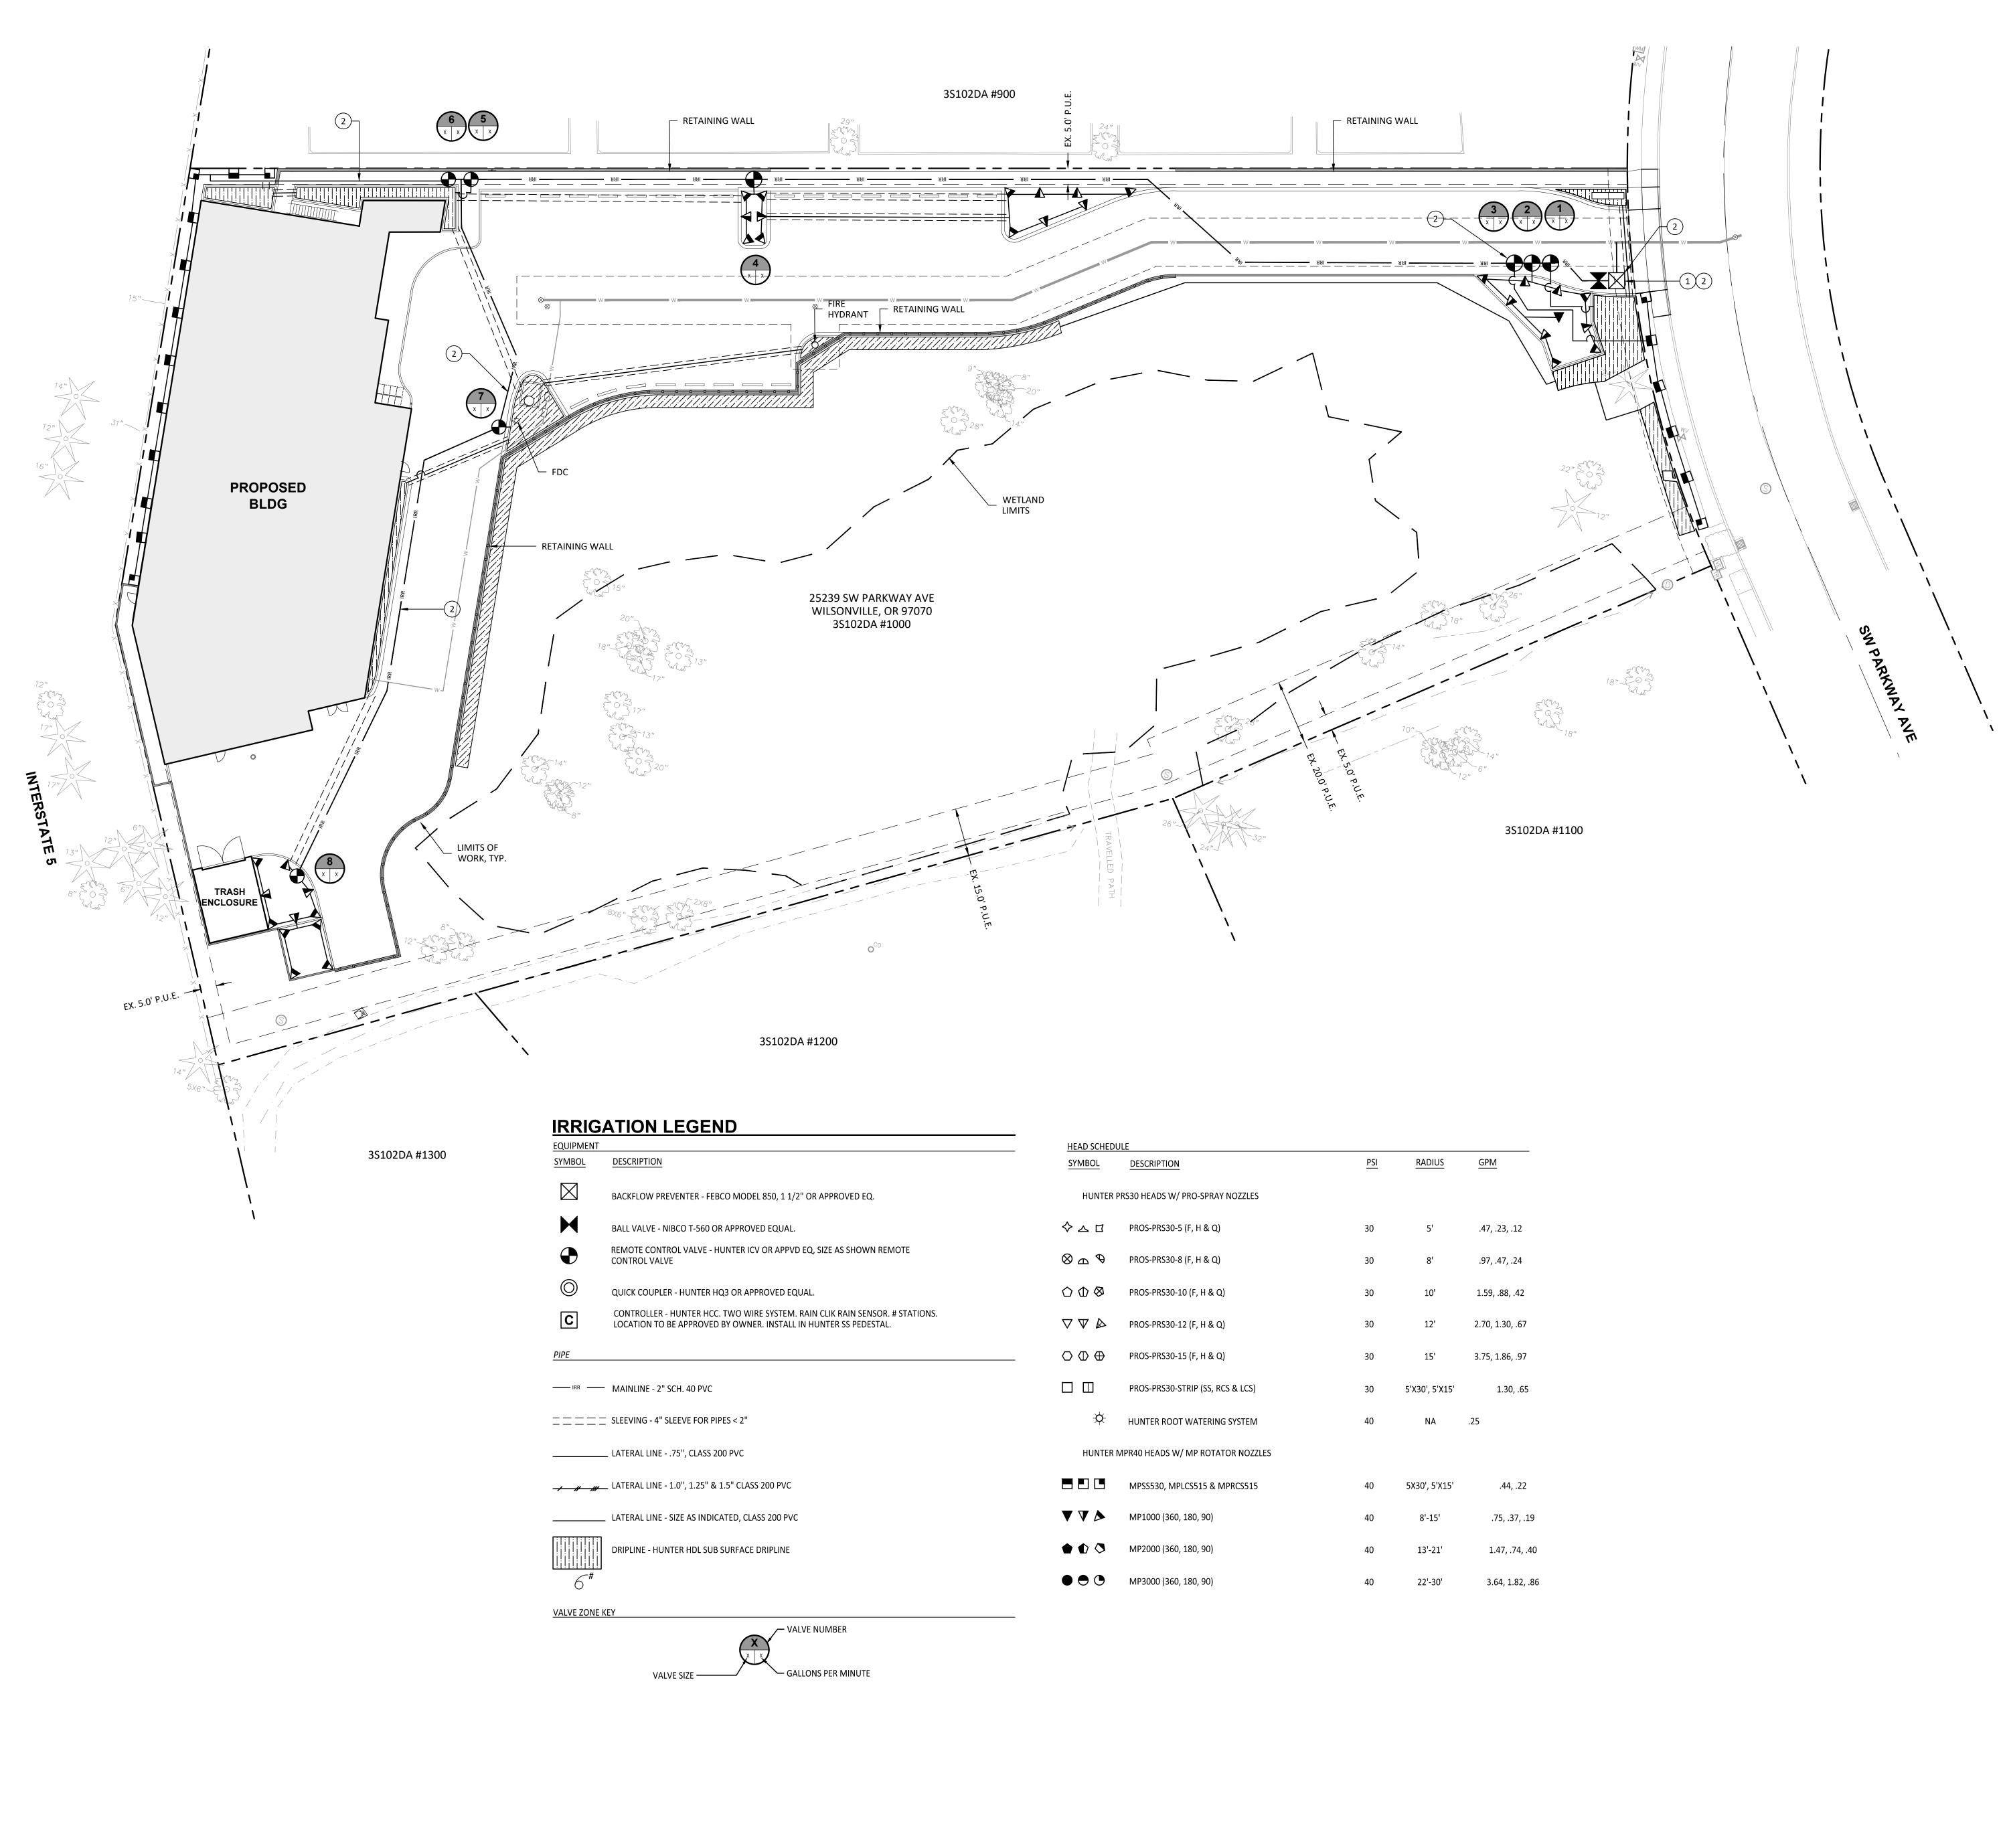

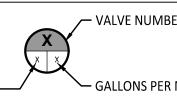

✓ VALVE NUMBER	
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PIPES < 2"		
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<u>HEAD SCHEDU</u>	LE			
SYMBOL	DESCRIPTION	PSI	RADIUS	GPM
HUNTER P	RS30 HEADS W/ PRO-SPRAY NOZZLES			
♦ य ष	PROS-PRS30-5 (F, H & Q)	30	5'	.47, .23, .12
$\theta ext{ } \blacksquare \otimes$	PROS-PRS30-8 (F, H & Q)	30	8'	.97, .47, .24
$\bigcirc \bigcirc \oslash \otimes$	PROS-PRS30-10 (F, H & Q)	30	10'	1.59, .88, .42
$\nabla \nabla \triangleright$	PROS-PRS30-12 (F, H & Q)	30	12'	2.70, 1.30, .6
$\bigcirc \oplus \oplus \\$	PROS-PRS30-15 (F, H & Q)	30	15'	3.75, 1.86, .9
	PROS-PRS30-STRIP (SS, RCS & LCS)	30	5'X30', 5'X15'	1.30, .6
\	HUNTER ROOT WATERING SYSTEM	40	NA	.25
HUNTER N	IPR40 HEADS W/ MP ROTATOR NOZZLES			
	MPSS530, MPLCS515 & MPRCS515	40	5X30' <i>,</i> 5'X15'	.44, .2
♥♥♪	MP1000 (360, 180, 90)	40	8'-15'	.75, .37,
	MP2000 (360, 180, 90)	40	13'-21'	1.47, .74
		HUNTER PRS30 HEADS W/ PRO-SPRAY NOZZLES ◇ △ □ PROS-PRS30-5 (F, H & Q) ◇ △ ◇ PROS-PRS30-8 (F, H & Q) ○ △ ◇ PROS-PRS30-10 (F, H & Q) ◇ ◇ ◇ PROS-PRS30-12 (F, H & Q) ○ ◇ ◇ PROS-PRS30-15 (F, H & Q) ○ ○ PROS-PRS30-15 (F, H & Q)	SYMBOL DESCRIPTION PSI HUNTER PRS30 HEADS W/ PRO-SPRAY NOZZLES 30 ◇ △ ◇ PROS-PRS30-5 (F, H & Q) 30 ◇ △ ◇ PROS-PRS30-6 (F, H & Q) 30 ◇ △ ◇ PROS-PRS30-8 (F, H & Q) 30 ◇ △ ◇ PROS-PRS30-10 (F, H & Q) 30 ◇ ◇ ◇ PROS-PRS30-12 (F, H & Q) 30 ◇ ◇ ◇ PROS-PRS30-15 (F, H & Q) 30 ○ ◇ ◇ PROS-PRS30-15 (F, H & Q) 30 ○ ◇ ◇ PROS-PRS30-15 (F, H & Q) 30 ○ ◇ ◇ PROS-PRS30-15 (F, H & Q) 30 ○ ◇ ◇ PROS-PRS30-15 (F, H & Q) 30 ○ ◇ ◇ PROS-PRS30-15 (F, H & Q) 30 ○ ◇ ◇ PROS-PRS30-5 TRIP (SS, RCS & LCS) 30 □ □ PROS-PRS30-5TRIP (SS, RCS & LCS) 30 □ □ PROS-PRS30-5TRIP (SS, RCS & LCS) 30 □ □ PROS-PRS30-5TRIP (SS, RCS & LCS) 40 □ □ NPSS530, MPLCS515 & MPRCS515 40 □ □ MPSS530, MPLCS515 & MPRCS515 40 □ □ MP1000 (360, 180, 90) 40	SYMBOL DESCRIPTION PSI RADIUS HUNTER PRS30 HEADS W/ PRO-SPRAY NOZZLES 30 5' ◇ △ ⑦ PROS-PRS30-5 (F, H & Q) 30 5' ◇ △ ⑦ PROS-PRS30-8 (F, H & Q) 30 8' ○ ① ◇ PROS-PRS30-10 (F, H & Q) 30 10' ○ ⑦ ◇ PROS-PRS30-12 (F, H & Q) 30 12' ○ ⑦ ◇ PROS-PRS30-15 (F, H & Q) 30 15' ○ ⑦ ◇ PROS-PRS30-15 (F, H & Q) 30 5'x30', 5'X15' ↓ ○ ⑦ ◇ PROS-PRS30-5TRIP (SS, RCS & LCS) 30 5'x30', 5'X15' ↓ □ PROS-PRS30-STRIP (SS, RCS & LCS) 30 5'x30', 5'X15' ↓ □ PROS-PRS30, MPICS515 & MPRCS515 40 NA HUNTER ROOT WATERING SYSTEM 40 5X30', 5'X15' ↓ □ MPISS530, MPICS515 & MPRCS515 40 5X30', 5'X15' ↓ ▼ ▲ MP1000 (360, 180, 90) 40 8'-15'

KEY NOTES

1 POINT OF CONNECTION - DOMESTIC WATER LINE, SEE CIVIL ULITIY PLANS


2 IRRIGATION PLANS ARE SCHEMATIC REPRESENTATIONS ONLY. PLACE LINES AND VALVES IN PLANTER AREAS EXCEPT WHERE SLEEVES ARE SHOWN.

IRRIGATION NOTES

- 1. CONTRACTOR SHALL INSPECT SITE AND VERIFY CONDITIONS AND DIMENSIONS PRIOR TO CONSTRUCTION.
- 2. IRRIGATION PLANS ARE SCHEMATIC REPRESENTATIONS ONLY. PLACE LINES IN COMMON TRENCH WHENEVER POSSIBLE. FIELD ADJUST LINES TO AVOID CONFLICT WITH UTILITIES.
- 3. IRRIGATION LATERAL AND MAINLINE PIPE SHOW OUTSIDE OF PLANTING AREAS FOR CLARIFICATION ONLY. PLACE LATERAL AND MAINLINE PIPE IN PLANTER AREAS UNLESS IRRIGATION SLEEVES ARE SHOWN.
- 4. COORDINATE IRRIGATION WITH PLANTING PLAN AND SITE IMPROVEMENTS AND USE TRIANGULAR SPACING FOR HEAD TO HEAD COVERAGE. COORDINATE IRRIGATION HEAD LAYOUT WITH NEW PLANT MATERIALS, LOCATE SPRAY HEADS 30" FROM BASE OF TREE. DO NOT ALTER HEAD LOCATION, PIPE LAYOUT, OR VALVE LOCATION WITHOUT WRITTEN APPROVAL FROM CONSTRUCTION MANAGER. NOTIFY OWNER'S REPRESENTATIVE IF DISCREPANCIES OCCUR BETWEEN PLANS AND FIELD CONDITIONS.
- 5. ALL COMPONENTS OF IRRIGATION SYSTEM SHALL BE INSTALLED AND PROPERLY ADJUSTED TO PROVIDE ADEQUATE COVERAGE AND MINIMIZATION OF OVERSPRAY ONTO WALKS, BUILDINGS, PARKING AREAS, ETC.
- 6. ALL PIPE SIZES INDICATED ARE MINIMUMS. CONTRACTOR MAY NOT DECREASE PIPE SIZE. LARGER PIPE SIZES MAY BE USED AT NO ADDITIONAL COST TO OWNER.
- ALL PAVED SURFACES UNLESS OTHERWISE INDICATED ON PLANS. INSTALL SLEEVES PRIOR TO PLACEMENT OF PAVEMENTS AND PAVEMENT SUB-BASE. 8. COORDINATE IRRIGATION POINTS OF CONNECTION AND LOCATION OF AUTOMATIC
- TRADES, I.E. ELECTRICAL, MASONRY, ETC.
- 9. CONTRACTOR TO PROGRAM AUTOMATIC CONTROLLER TO ALLOW FOR EQUIVALENT OF 1" OF WATER PER WEEK, OR PER SITE AND PLANTING NEEDS FOR BEST PLANT HEALTH.
- 10. ALL PIPES SHALL BE TRENCHED. PROVIDE POSITIVE DRAINAGE OF MAINLINE. PLACE MANUAL DRAIN AT LOW POINTS IN MAINLINE. IDENTIFY LOCATIONS ON AS-BUILTS.
- 11. USE 45° ELLS INSTEAD OF 90° ELLS ON ALL MAINLINES 2-1/2" AND LARGER. INSTALL CONCRETE THRUST BLOCKS AT ALL MAINLINE CHANGES IN DIRECTION. POUR MINIMUM OF 1 CUBIC FOOT OF CONCRETE ON UNDISTURBED SOIL. WRAP PIPE IN PLASTIC WRAP PRIOR TO COVERING WITH CONCRETE.
- 12. CONTRACTOR TO INSTALL CONTROLLER AND ACCESSORIES AS REQUIRED. CONTRACTOR TO FURNISH CONTROL WIRES FROM VALVES TO CONTROLLER. CONTRACTOR SHALL BE RESPONSIBLE FOR COORDINATING 110 VOLT SERVICE FROM BUILDING AND CONNECTION TO CONTROLLER SERVICE.
- 13. IRRIGATION SYSTEMS SHALL BE TWO (2) WIRE DECODER CONTROL SYSTEMS UNLESS MULTI-WIRE SYSTEM IS SPECIFIED. CONTRACTOR TO PROVIDE DECODERS FOR EACH REMOTE CONTROL VALVE.
- 14. ALL SPRINKLER BODIES TO BE 6" POP-UP IN LAWN AREAS AND 12-INCH POP-UP IN SHRUB, GROUNDCOVER AND STORM WATER PLANTER AREAS.

7. INSTALL ALL IRRIGATION PIPE AND CONTROL WIRES IN MINIMUM 4" PVC SLEEVE BELOW

CONTROL VALVES WITH PROJECT MANAGER. COORDINATE ALL WORK WITH OTHER

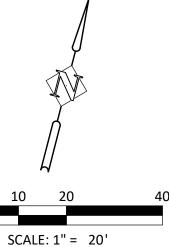



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REVISIONS		
No.	Description	Date
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DRAWN BY: HHPR CHECKED BY: HHPR JOB NO: 22-033

DATE: 10/04/2024

ISSUED FOR: PRELIMINARY

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SHEET TITLE IRRIGATION PLAN

